HOBART INTERIM PLANNING SCHEME: 10. GENERAL RESIDENTIAL AREA

10.4.1 Residential density for multiple dwellings.

A1(a) - The proposed development has a site area area of 754m2, with two dwellings proposed at a site area per dwelling of 377m2. [Compliant].

10.4.2 Setbacks and building envelopes for all dwellings.

A1(a) - The proposed dwelling is setback from the primary frontage over 4.5m. [Compliant].

A2(a)(b)(c) - Not applicable - no garage or carport proposed. [Compliant].

P3(a)(b) - The proposed dwelling has been sited and designed to a scale that does not cause an unreasonable lose of amenity to dwellings on adjacent lots (i), or the private space of an adjoining lots (ii) (refer also to shadow study on page 900 and photographs 901). As illustrated in the shadow study, the scale and position of house b, on the 21st June, has no impact on the POS of 213 Churchill ave until between 11am and midday, during which it still maintains over 50% of accessible sunlight until between 1 and 2pm. This means that there is only approximately 1.5hrs on the longest day of the year that shades more than 50% of the POS of 213. Either side of this day there will be less impact to the POS of 213 Churchill throughout the year. Note also as per the shadow study that 213 Churchill has a number of trees on the north-western boundary that currently creates similar if not further shadowing impact than the proposed new dwelling.

The siting and massing of the proposed dwelling to the side boundaries takes into consideration appropriate setbacks common to the surrounding neighbouring area. The north-west side has a setback of 5m which is similar to the existing dwelling. The south-west boundary is setback over 1.5m on the ground floor, and pulls further away from the boundary on the higher levels to minimise the visual bulk and overshadowing to 213 with the first floor setback 3.2m and the second floor 5.1m.

The total height of the dwelling from natural ground is 8.35m. The impact of the height is softened due to digging the ground floor into the site with adjacent retaining walls; and being downslope from Churchill ave. This means the the roof top of the proposed dwelling is only approx. 1m higher than the existing roof at 213 Churchill ave, and the property therefore comfortably sits within its urban context when viewed from Churchill ave. The bulk and scale of the dwelling sits within the context of the neighbourhood with a number of higher density and multi-residential projects, and is therefore an appropriate increase in density.

The materiality of the proposed dwelling uses three distinct colours to break up the height and massing. The ground floor uses a dark brown brick to create a solid plinth for the building to connect to the earth. The second and third floor share the use of a lighter cream coloured brick, giving the impression of a two story building. The top 1m of the second story uses a white painted cement sheet and glazing that is stepped back from the brick to create a thin band wrapping around the building that invokes a lightness to the roof. Where the proposed dwelling steps back off the boundary on the upper levels, painted white cement sheet has been used due to its sheet-form that creates a rhythm to the facade of the building, rather than the flat face created by brick.

10.4.3 Site coverage and private open space for all dwellings

A1(a)(b)(c) - Each dwelling has over 24m2 of private open space, with a minimum horizontal dimension of 4m, is located adjacent to a habitable room, and is located to the north-west, receiving over 3hrs sunlight to 50% area between 9-3 on on June 21st, has a gradient not steeper than 1:10 and is not used for vehicle access or parking (refer to page 101) [Compliant].

10.4.4 Sunlight and overshadowing for all dwellings

A1 - The proposed dwelling has multiple windows that face 30deg west or north and 30 deg east of north. [Compliant].

A2 (a)(b)(c) - The proposed dwelling does not cause 50% of the POS to receive less than 3hours of sunlight between 9am and 3pm on the 21st June (refer to drawing 900). [Compliant].

10.4.5 Privacy for all dwellings

A1(a)(b)(c) - There are no proposed balcony, deck, roof terrace or parking spaces that are 1m above natural ground. [Compliant].

P2(a) - A window or glazed door to a habitable room of the proposed dwelling with a floor level above 1m (this applies only to the first and second story of proposed house B) is located and designed to minimise direct views, with the following setbacks:

- North-west (side boundary) setback all levels 5m.
- South-west (side boundary) setback first floor 3.2m, second floor 5.1m.
- North-east (front boundary road) setback, between 0.4m and 1.5m.
- South-east (House A) setback 7.5m

Where the first and second level floors are above 1m from natural ground, the building steps backs a significant amount (as noted above) from the side boundaries to prevent overlooking from glazed windows. Both adjacent side properties are predominately private open space with trees and foliage on the boundary that will further prevent overlooking (refer to page 901).

The building front (north-east) boundary is adjacent to an unsealed road which is approximately 6.5m wide to the next property. This road services several carports, and has no throughofare for pedestrians. The first and second floors are therefore setback between 6.9m to 8.5m from the next property boundary. This will minimise any impact on the next adjacent property and importantly gains the maximum benefit of the north-eastern aspect for comfort of the occupants in House B in energy efficiency. In addition, all second floor windows have a sill height of 1350mm.

A3(a)(b) - The proposed dwelling parking spaces are adjacent to their respective dwellings. The existing House A has a windows that are adjacent to the parking for house B and have a sill height of over 1.7m above the parking space (refer to page 901). [Compliant].

10.4.7 Frontage fences for all dwellings

A1(a)(b) - No proposed changes to frontage fence. [Compliant]

10.4.8 Waste storage for multiple dwellings

A1(a)(b) - Both dwellings have bin storage for exclusive use of each dwelling. [Compliant]

DEVELOPMENT APPLICATION FOR

211 CHURCHILL AVE.

LOT 9, VOL 55834 PID 5607522

WIND SPEED: N2 SOIL CLASSIFICATION: H1 CLIMATE ZONE: 7 BAL: NONE

001 CONTENTS

100 EXISTING/DEMOLITION SITE PLAN

101 PROPOSED SITE PLAN

200 PROPOSED FLOOR PLAN GROUND

201 PROPOSED FLOOR PLAN FIRST

202 PROPOSED FLOOR PLAN SECOND

203 PROPOSED ROOF PLAN

300 PROPOSED ELEVATIONS NORTH-EAST, NORTH-WEST

301 PROPOSED ELEVATIONS SOUTH-EAST, SOUTH-WEST

900 SHADOW STUDY

901 PHOTOGRAPHS

NOTE: THIS APPLICATION IS DUE TO THE PREVIOUS PLANNING PERMIT **(PLN-15-1003-01)** AND FOLLOWING AMENDMENT (09/2016) NOT BEING RENEWED WITHIN 6 MONTHS OF EXPIRY.

THE FOLLOWING APPROVALS ARE CURRENT:

BUILDING APPROVAL: BLD-17-104 PLUMBING APPROVAL: PMB-17-51

AREA ANALYSIS

 SITE:
 754m2

 EX. HOUSE:
 101m2


 PROPOSED HOUSE:
 122m2


 PROPOSED

 SITE COVERAGE
 29.5%

TITLE TO BE CONVERTED TO STRATA ONCE BUILD COMPLETE


NEXT 50

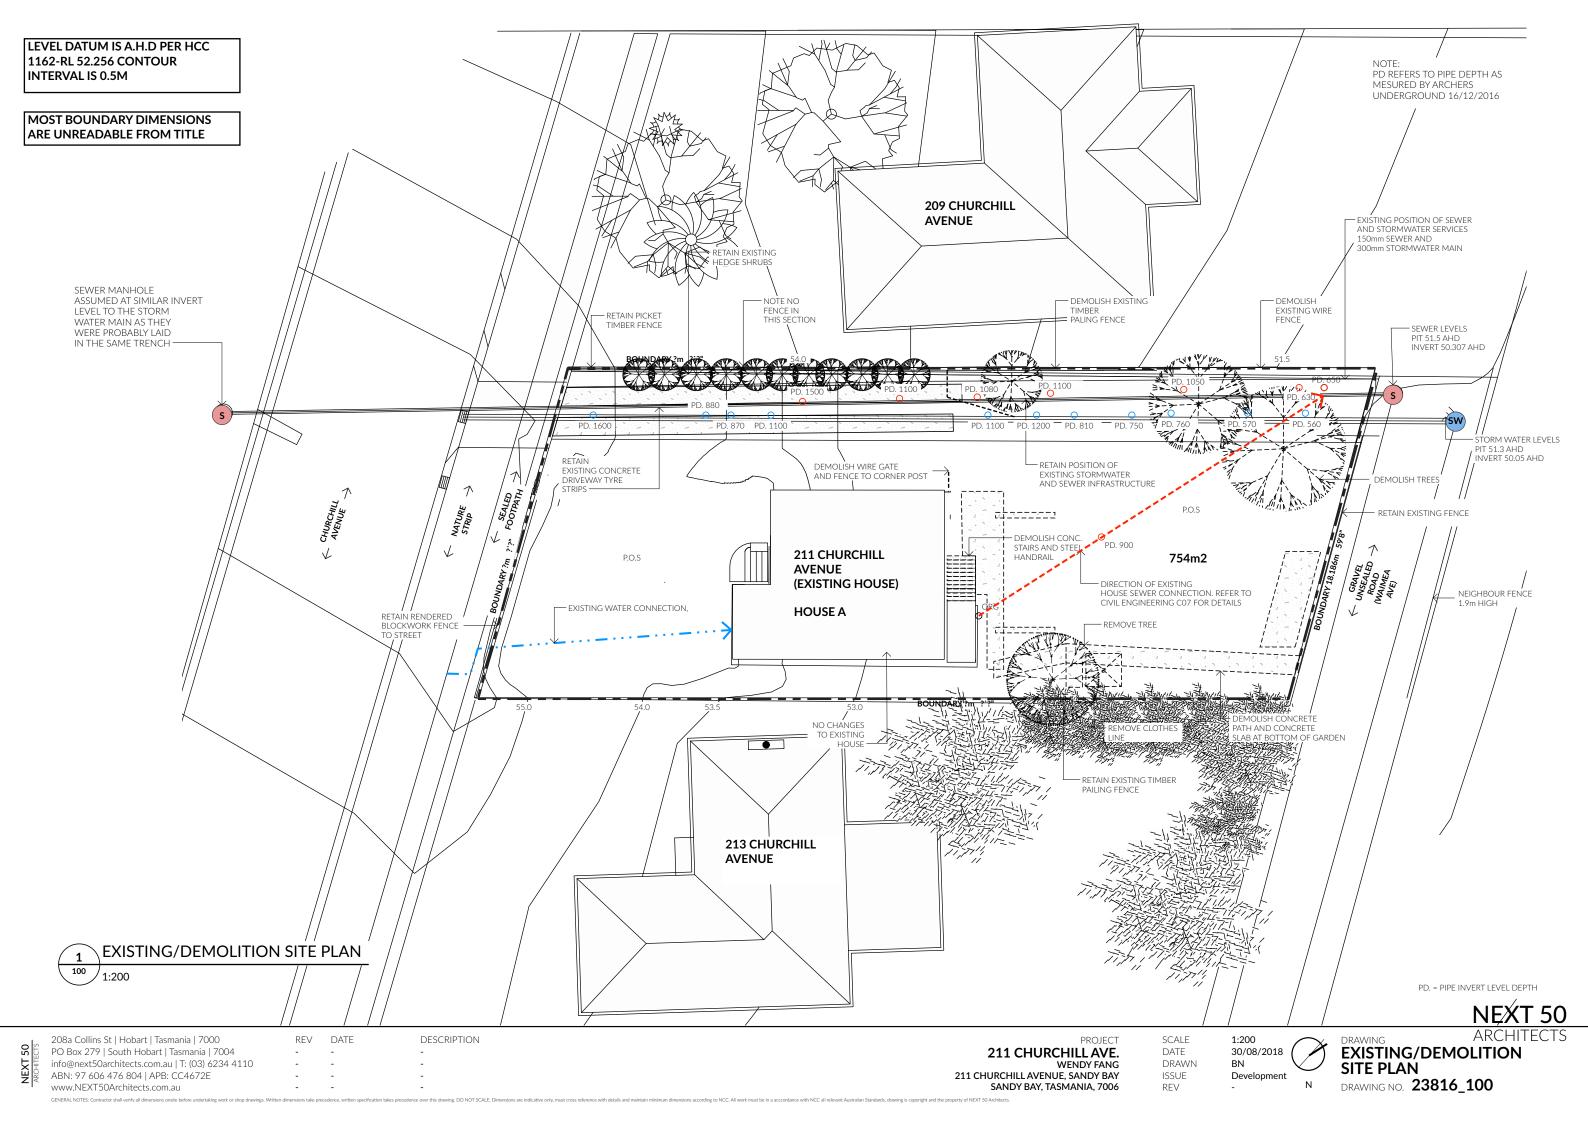

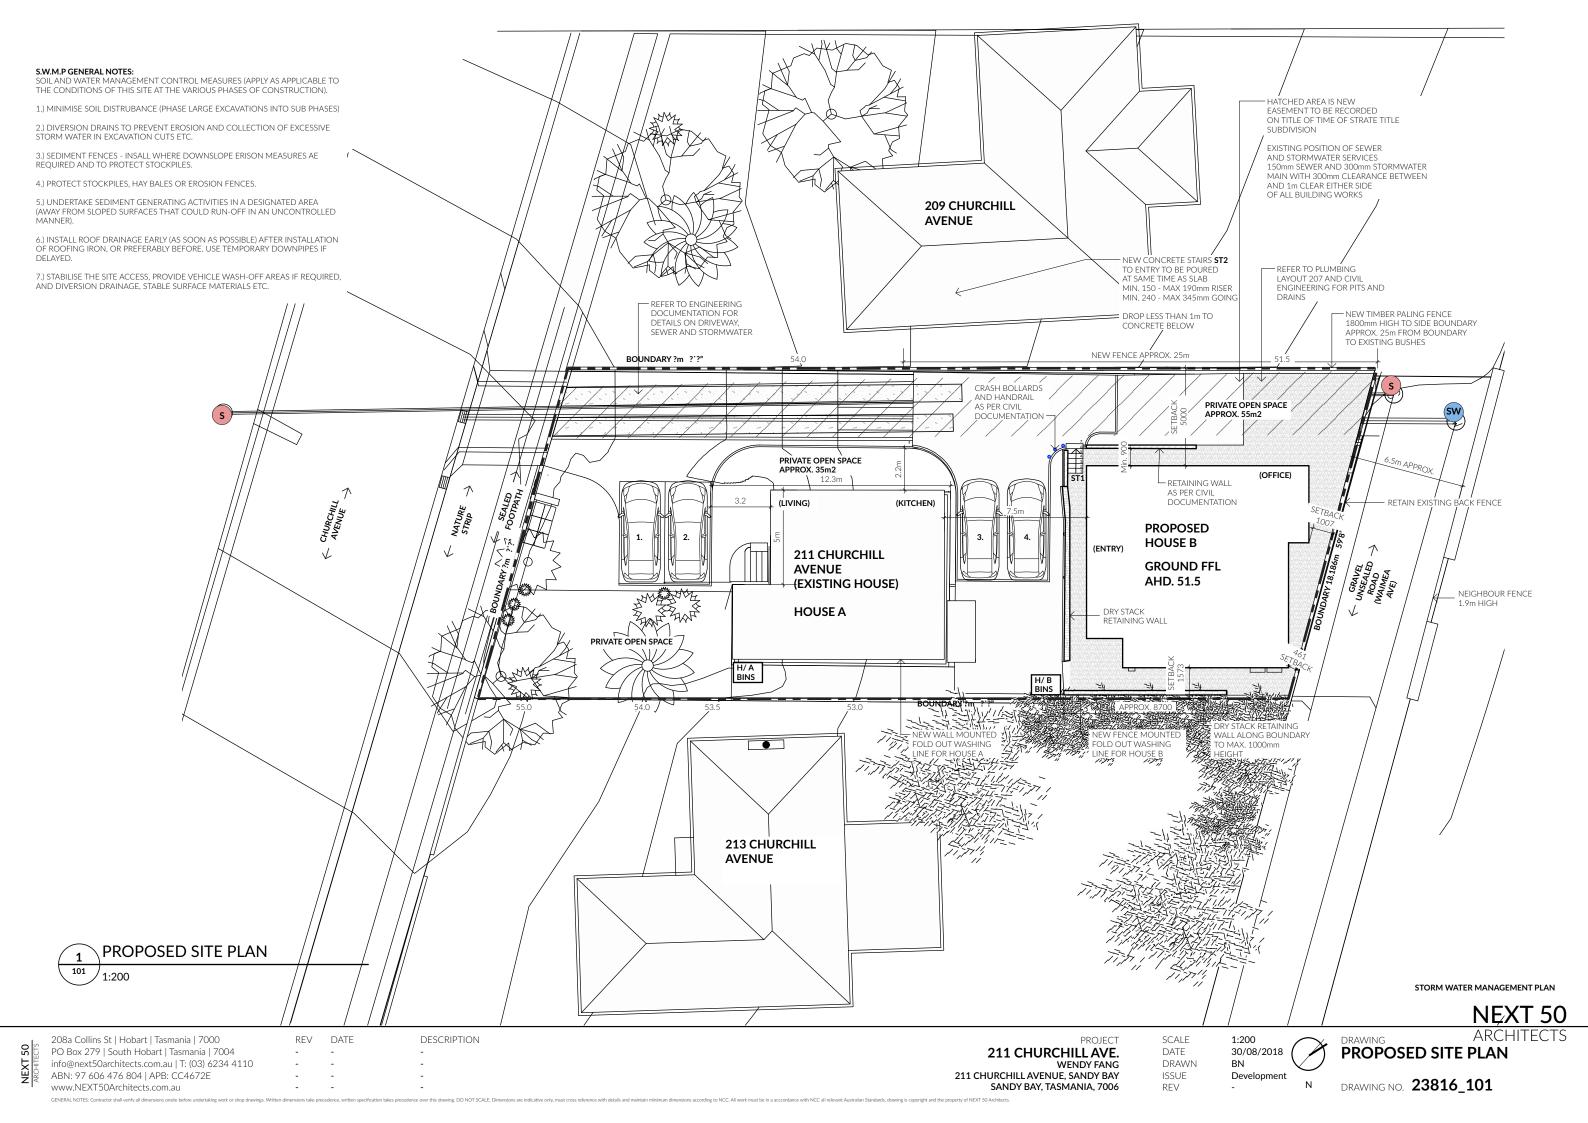



PO Box 279 | South Hobart | Tasmania | 7004 info@next50architects.com.au | T: (03) 6234 4110 ABN: 97 606 476 804 | APB: CC4672E

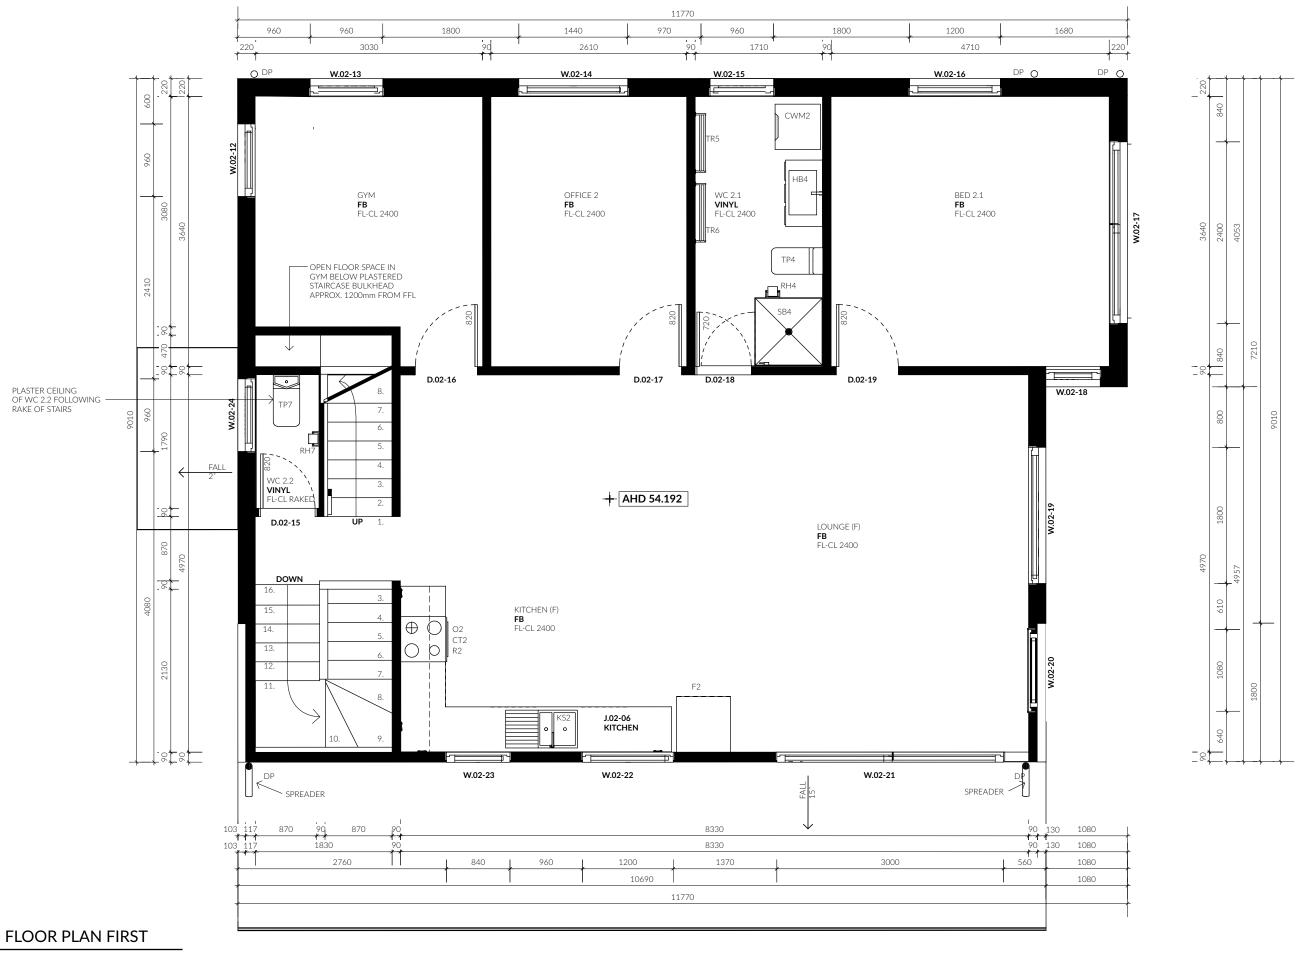

PROPOSED FLOOR PLAN FIRST 201 1:50

NEXT 50

208a Collins St | Hobart | Tasmania | 7000 REV DATE PO Box 279 | South Hobart | Tasmania | 7004 info@next50architects.com.au | T: (03) 6234 4110 ABN: 97 606 476 804 | APB: CC4672E www.NEXT50Architects.com.au

DESCRIPTION

PROJECT
211 CHURCHILL AVE.
WENDY FANG 211 CHURCHILL AVENUE, SANDY BAY SANDY BAY, TASMANIA, 7006

SCALE DATE 30/08/2018 DRAWN BN ISSUE REV

Development

PROPOSED FLOOR PLAN **FIRST** DRAWING NO. 23816_201



PROPOSED FLOOR PLAN SECOND 1 202 1:50

NEXT 50

208a Collins St | Hobart | Tasmania | 7000 PO Box 279 | South Hobart | Tasmania | 7004 info@next50architects.com.au | T: (03) 6234 4110 ABN: 97 606 476 804 | APB: CC4672E


DESCRIPTION REV DATE

PROJECT 211 CHURCHILL AVE. WENDY FANG 211 CHURCHILL AVENUE, SANDY BAY SANDY BAY, TASMANIA, 7006

SCALE DATE 30/08/2018 DRAWN ISSUE

Development

ARCHITECTS PROPOSED FLOOR PLAN **SECOND** DRAWING NO. 23816_202

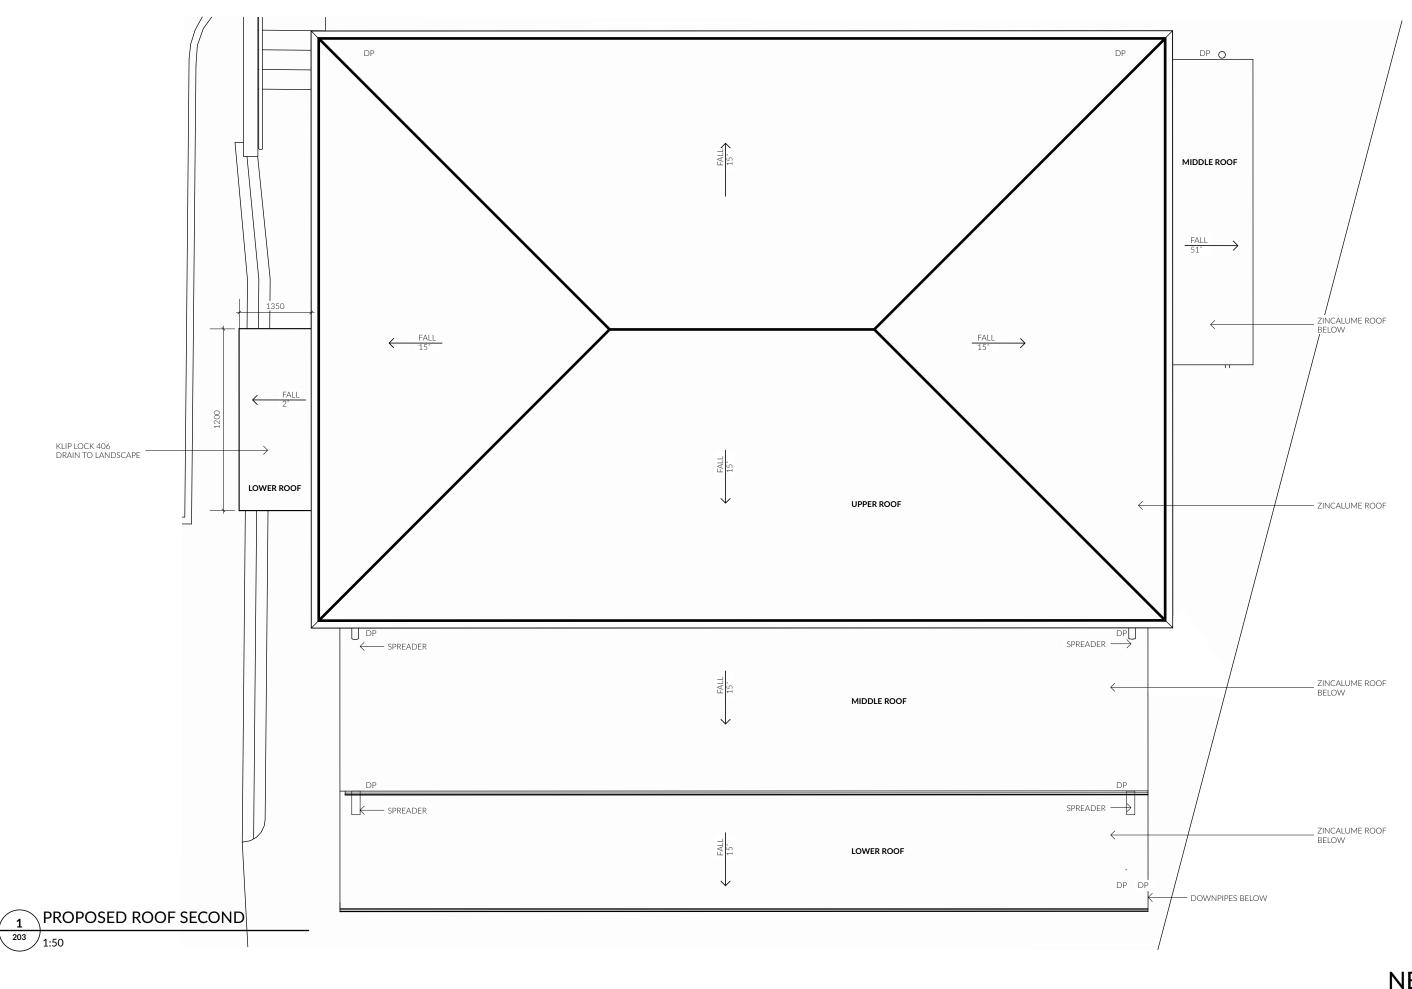

208a Collins St | Hobart | Tasmania | 7000 PO Box 279 | South Hobart | Tasmania | 7004 info@next50architects.com.au | T: (03) 6234 4110 ABN: 97 606 476 804 | APB: CC4672E

REV DATE DESCRIPTION PROJECT

211 CHURCHILL AVE.

WENDY FANG
211 CHURCHILL AVENUE, SANDY BAY
SANDY BAY, TASMANIA, 7006

SCALE DATE 30/08/2018 DRAWN ISSUE Development REV

NEXT 50 ARCHITECTS PROPOSED ROOF PLAN

DRAWING NO. 23816_202



KEY


(R) ROOF IRON

B1 BRICK TYPE 1

B2 BRICK TYPE 2

(FC) CEMENT SHEET

(CB) COLORBOND

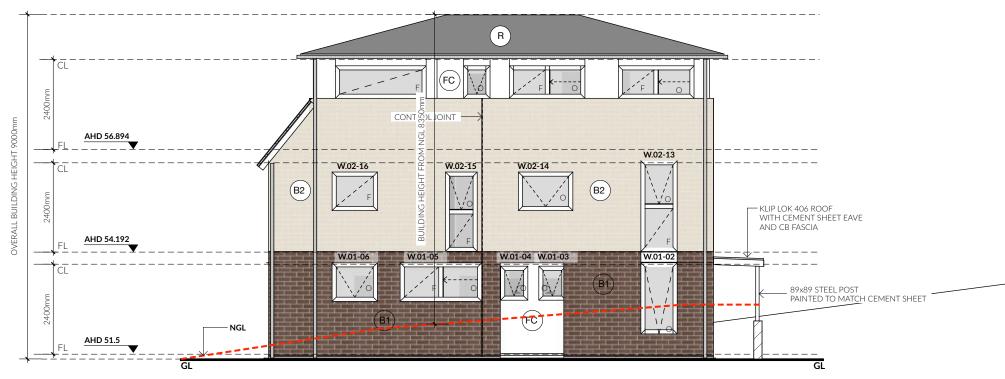

PROPOSED NORTH-WEST ELEVATION 300 1:100

NEXT 50

208a Collins St | Hobart | Tasmania | 7000 PO Box 279 | South Hobart | Tasmania | 7004 info@next50architects.com.au | T: (03) 6234 4110 ABN: 97 606 476 804 | APB: CC4672E www.NEXT50Architects.com.au

DESCRIPTION REV DATE

PROJECT
211 CHURCHILL AVE.
WENDY FANG 211 CHURCHILL AVENUE, SANDY BAY SANDY BAY, TASMANIA, 7006

SCALE 1:100 DATE DRAWN ISSUE REV

30/08/2018 Development

PROPOSED ELEVATIONS NORTH-EAST, NORTH-WEST DRAWING NO. 23816_300




KEY

(R) ROOF IRON

B1) BRICK TYPE 1

B2 BRICK TYPE 2

(FC) CEMENT SHEET

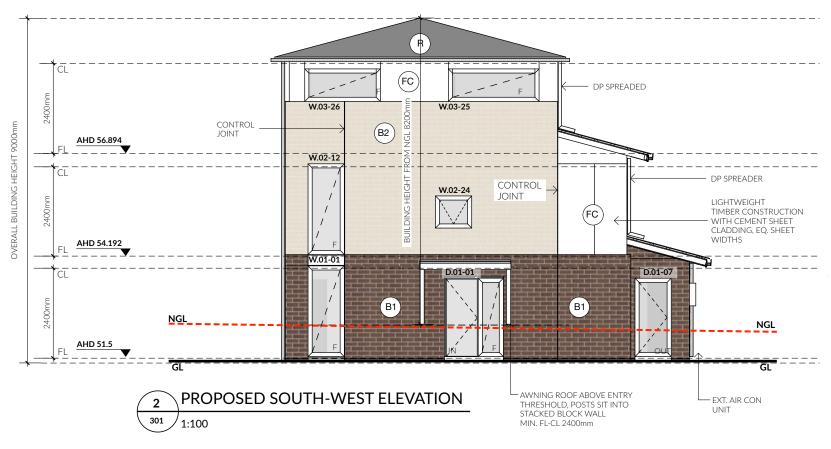

NEXT 50

208a Collins St | Hobart | Tasmania | 7000 PO Box 279 | South Hobart | Tasmania | 7004 info@next50architects.com.au | T: (03) 6234 4110 ABN: 97 606 476 804 | APB: CC4672E www.NEXT50Architects.com.au PROJECT

211 CHURCHILL AVE.
WENDY FANG
211 CHURCHILL AVENUE, SANDY BAY
SANDY BAY, TASMANIA, 7006

 SCALE
 1:100


 DATE
 30/08/2018


 DRAWN
 BN


 ISSUE
 Development

 REV

DRAWING ARCHITECT:
PROPOSED ELEVATIONS
SOUTH-EAST, SOUTH-WEST
DRAWING NO. 23816_301

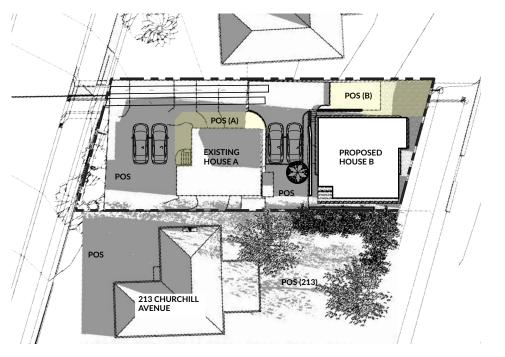

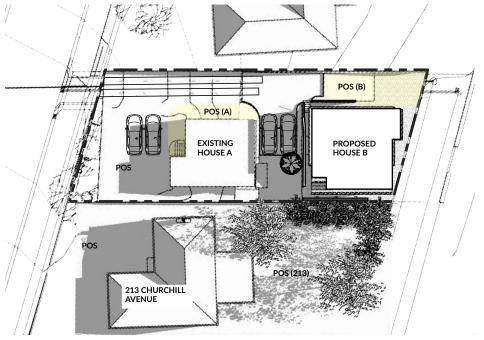

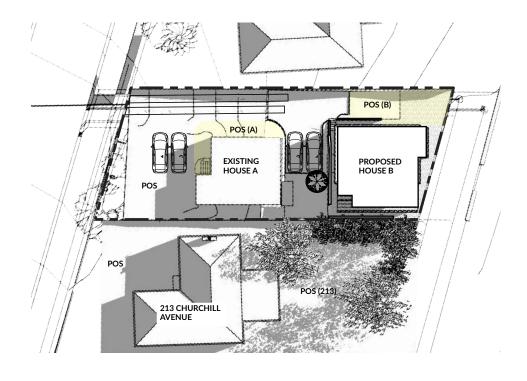

100% SUN 100% SUN 100% SUN

∑21st June 11am POS A: POS B: POS 213: 900 1:500

6 21st June 2pm

1:500

PROPOSED HOUSE B **EXISTING** POS 213 CHURCHILL AVENUE

21st June 9am POS A: POS B: POS 213: NO SUN 50% SUN 100% SUN 900 1:500

1:500

900

21st June 10am


100% SUN 100% SUN 100% SUN

POS A: POS B: POS 213:

PO\$ (A) EXISTING HOUSE A PROPOSED HOUSE B 213 CHURCHILL AVENUE

\21st June Midday 900 1:500

POS A: POS B: POS 213: 100% SUN 60% SUN (FENCE) 80% SUN

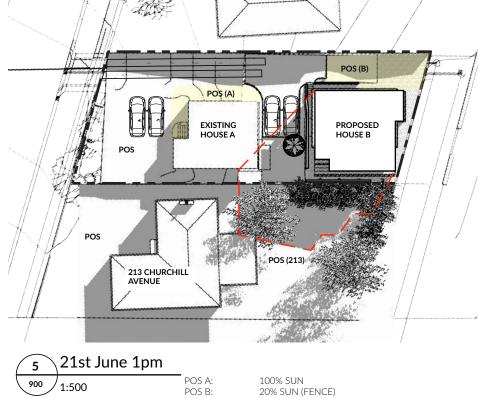

POS 213:

900

1:500

100% SUN 20% SUN (FENCE) 60% SUN

NEXT 50

208a Collins St | Hobart | Tasmania | 7000 PO Box 279 | South Hobart | Tasmania | 7004 info@next50architects.com.au | T: (03) 6234 4110 ABN: 97 606 476 804 | APB: CC4672E www.NEXT50Architects.com.au

REV DATE

DESCRIPTION

PROJECT
211 CHURCHILL AVE.
WENDY FANG 211 CHURCHILL AVENUE, SANDY BAY SANDY BAY, TASMANIA, 7006

900

SCALE DATE DRAWN ISSUE REV

POS A: POS B: POS 213:


1:100 30/08/2018 Development

30% SUN 0% SUN (FENCE)

25% SUN

ARCHITECTS **SHADOW STUDY**

DRAWING NO. **23816_900**

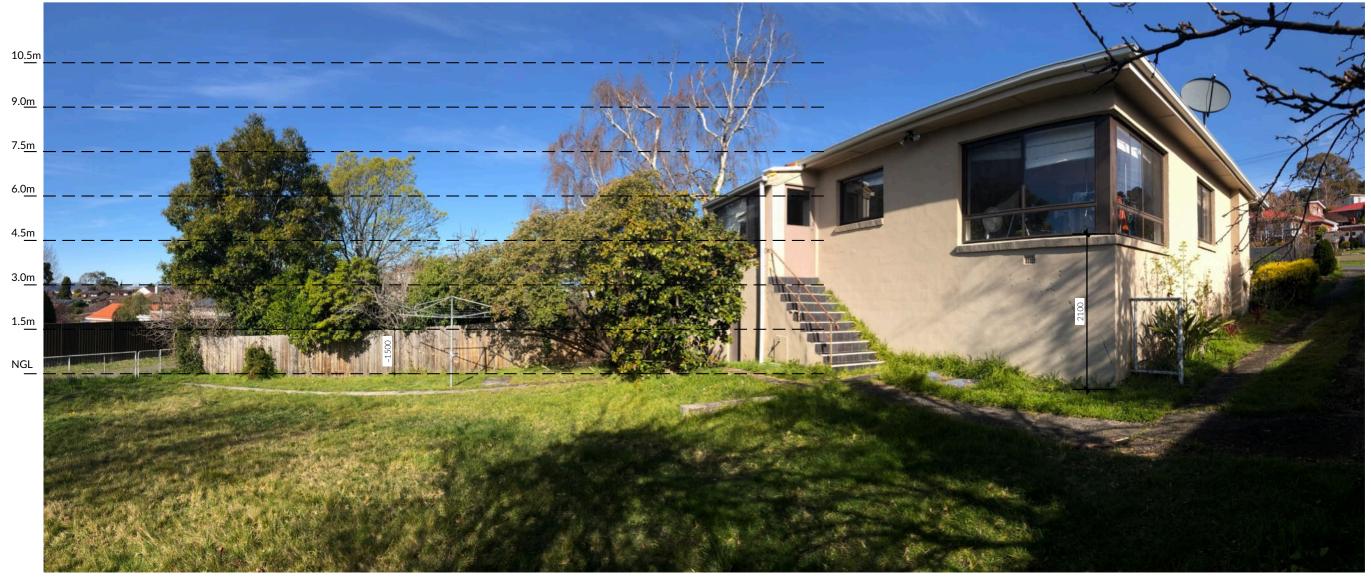

No. 213 TREES [10.4.2 A1] TAKEN 30/08/2018 1:20pm

EXISTING A BACK WINDOWS [10.4.5 A3]

NEXT 50 ARCHITECTS

208a Collins St | Hobart | Tasmania | 7000 PO Box 279 | South Hobart | Tasmania | 7004 info@next50architects.com.au | T: (03) 6234 4110 ABN: 97 606 476 804 | APB: CC4672E www.NEXT50Architects.com.au

DESCRIPTION REV DATE

PROJECT

211 CHURCHILL AVE.

WENDY FANG
211 CHURCHILL AVENUE, SANDY BAY
SANDY BAY, TASMANIA, 7006

NTS 30/08/2018 Development

SCALE DATE

DRAWN ISSUE REV

PHOTOGRAPHS

DRAWING NO. **23816_901**



RESULT OF SEARCH

RECORDER OF TITLES

Issued Pursuant to the Land Titles Act 1980



SEARCH OF TORRENS TITLE

VOLUME	FOLIO g			
55834	9			
EDITION	DATE OF ISSUE			
4	01-Jun-2016			

SEARCH DATE : 24-Jun-2016 SEARCH TIME : 09.30 AM

DESCRIPTION OF LAND

City of HOBART

Lot 9 on Plan 55834 (formerly being P1057)

Derivation: Part of 42 Acres. Gtd. to J C Firth

Prior CT 2724/26

SCHEDULE 1


M574857 TRANSFER to WENFANG WU Registered 01-Jun-2016 at 12.

SCHEDULE 2

Reservations and conditions in the Crown Grant if any
BENEFITING EASEMENT: A right of carriage way over all roads
and right of way shown on Plan No. 1057
106405 BOUNDARY FENCES AND OTHER CONDITIONS in Transfer
E50011 MORTGAGE to Australia and New Zealand Banking Group
Limited Registered 01-Jun-2016 at 12.02 PM

UNREGISTERED DEALINGS AND NOTATIONS

No unregistered dealings or other notations

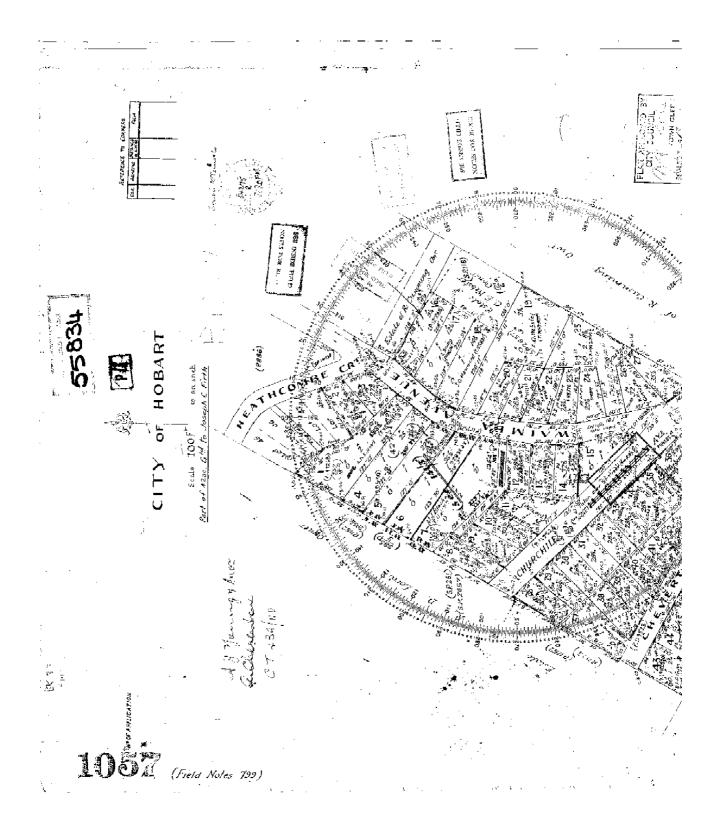





Submission to Planning Authority Notice

Council Planning Permit No.	PLN-18-603			Council notice date	12/09/2018		
TasWater details							
TasWater Reference No.	TWDA 2018/0151	WDA 2018/01513-HCC		Date of response	18/09/2018		
TasWater Contact	Anthony Cengia	thony Cengia Phone No.		(03) 6237 8243			
Response issued to							
Council name	HOBART CITY COUNCIL						
Contact details	coh@hobartcity.com.au						
Development details							
Address	211 CHURCHILL AVE, SANDY BAY			Property ID (PID)	5607522		
Description of development	Two multiple dwellings one existing, one new						
Schedule of drawings/documents							
Prepared by		Drawing/document No.		Revision No.	Date of Issue		
Next 50 Architects		23816 Sheet 101			30/08/2018		
Conditions							

SUBMISSION TO PLANNING AUTHORITY NOTICE OF PLANNING APPLICATION REFERRAL

Pursuant to the *Water and Sewerage Industry Act* 2008 (TAS) Section 56P(1) TasWater imposes the following conditions on the permit for this application:

CONNECTIONS, METERING & BACKFLOW

- A suitably sized water supply with metered connections / sewerage system and connections to each dwelling unit must be designed and constructed to TasWater's satisfaction and be in accordance with any other conditions in this permit.
- 2. Any removal/supply and installation of water meters and/or the removal of redundant and/or installation of new and modified property service connections must be carried out by TasWater at the developer's cost.

56W CONSENT

3. Prior to the issue of the Certificate for Certifiable Work (Building) and/or (Plumbing) by TasWater the applicant or landowner as the case may be must make application to TasWater pursuant to section 56W of the Water and Sewerage Industry Act 2008 for its consent in respect of that part of the development which is built within a TasWater easement or over or within two metres of TasWater infrastructure.

The plans submitted with the application for the Certificate for Certifiable Work (Building) and/or (Plumbing) must show footings of proposed buildings located over or within 2.0m from TasWater pipes and must be designed by a suitably qualified person to adequately protect the integrity of TasWater's infrastructure, and to TasWater's satisfaction, be in accordance with AS3500 Part 2.2 Section 3.8 to ensure that no loads are transferred to TasWater's pipes. These plans must also include a cross sectional view through the footings which clearly shows;

- Existing pipe depth and proposed finished surface levels over the pipe inclusive of a driveway long and cross sectional view demonstrating that a minimum cover of 750mm will be maintained;
- b. The line of influence from the base of the footing must pass below the invert of the pipe and



be clear of the pipe trench and;

c. A note on the plan indicating how the pipe location and depth were ascertained.

DEVELOPMENT ASSESSMENT FEES

4. The applicant or landowner as the case may be, must pay a development assessment fee of \$211.63 to TasWater, as approved by the Economic Regulator and the fees will be indexed, until the date paid to TasWater.

The payment is required within 30 days of the issue of an invoice by TasWater.

Advice

General

For information on TasWater development standards, please visit http://www.taswater.com.au/Development/Development-Standards

For application forms please visit http://www.taswater.com.au/Development/Forms

Declaration

The drawings/documents and conditions stated above constitute TasWater's Submission to Planning Authority Notice.

Authorised by

Jason Taylor

Development Assessment Manager

TasWater Contact Details						
Phone	13 6992	Email	development@taswater.com.au			
Mail GPO Box 1393 Hobart TAS 7001		Web	www.taswater.com.au			

Issue Date: August 2015
Page 2 of 2
Uncontrolled when printed
Version No: 0.1