


RESULT OF SEARCH

RECORDER OF TITLES



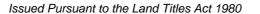

SEARCH OF TORRENS TITLE

VOLUME	FOLIO
48239	7
EDITION 3	DATE OF ISSUE 16-Sep-2015

SEARCH DATE : 20-Feb-2018 SEARCH TIME : 12.42 PM

DESCRIPTION OF LAND

City of HOBART Lot 7 on Diagram 48239 Being the land described in Conveyance No. 24/6281 Derivation: Part of 1A-1R-28Ps. Gtd. to H.S. Hurst Prior CT 4746/6

SCHEDULE 1

M417404 TRANSFER to DANIEL STAFFORD VAUTIN and SARAH

HENRIETTA VAUTIN Registered 04-Jul-2013 at 12.02 PM

SCHEDULE 2

Reservations and conditions in the Crown Grant if any E18285 MORTGAGE to National Australia Bank Limited Registered 16-Sep-2015 at 12.01 PM

UNREGISTERED DEALINGS AND NOTATIONS

No unregistered dealings or other notations




FOLIO PLAN


RECORDER OF TITLES



Issued Pursuant to the Land Titles Act 1980

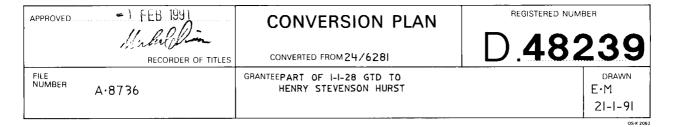

SKETCH BY WAY OF ILLUSTRATION ONLY

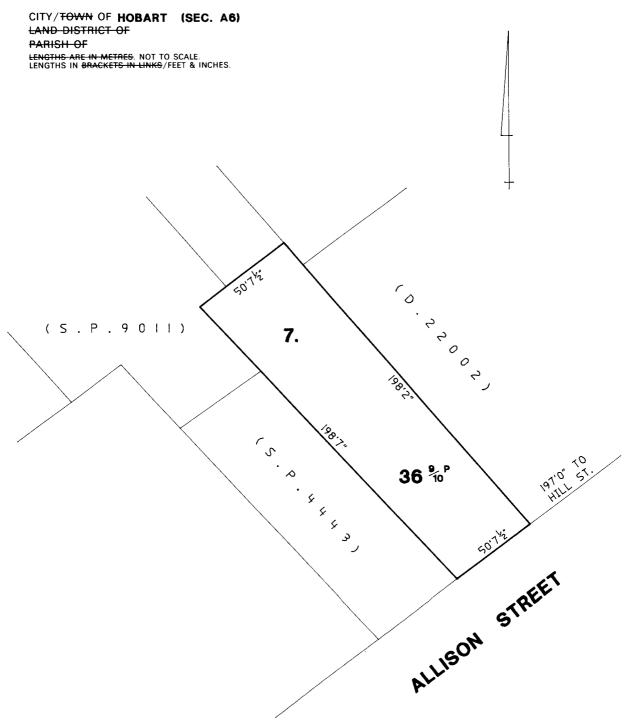

Volume Number: 48239 Search Date: 20 Feb 2018 Search Time: 12:42 PM Revision Number: 01

Page 1 of 1



RESULT OF SEARCH

RECORDER OF TITLES

Issued Pursuant to the Land Titles Act 1980



SEARCH OF TORRENS TITLE

VOLUME	FOLIO
161026	1
EDITION 2	DATE OF ISSUE

SEARCH DATE : 27-Jul-2018 SEARCH TIME : 12.00 PM

DESCRIPTION OF LAND

City of HOBART

Lot 1 on Plan 161026

Being the land described in Purchase Grant No.57/165

Derivation: Whole of 1A-OR-OP Gtd.to The Municipal Council of

the City of Hobart Derived from A24430

SCHEDULE 1

HOBART CITY COUNCIL

SCHEDULE 2

Reservations and conditions in the Crown Grant if any D34727 BURDENING ELECTRICITY INFRASTRUCTURE EASEMENT with the benefit of a restriction as to user of land in favour of Aurora Energy Pty Ltd over the Electricity Infrastructure Easement 5.20 wide shown on Plan 161026 (Subject to Provisions) Registered 18-Nov-2011 at noon

UNREGISTERED DEALINGS AND NOTATIONS

No unregistered dealings or other notations



FOLIO PLAN

RECORDER OF TITLES



Issued Pursuant to the Land Titles Act 1980


Registered Number **CONVERSION PLAN** FILE NUMBER A.24430 LOCATION P.161026 CITY OF HOBART (SECTION A.6.)

GRANTEE WHOLE OF IA-OR-OP GTD TO THE MUNICIPAL COUNCIL OF THE CITY OF HOBART APPROVED 17 NOV 2011 PG. 57/165 GL. (HOBART 70 L.O.) CONVERTED FROM Alice Kawa Recorder of Titles NOT TO SCALE LENGTHS IN METRES MAPSHEET MUNICIPAL CODE No. 114 (5225-42,52) ALL EXISTING SURVEY NUMBERS TO BE CROSS REFERENCED ON THIS PLAN LAST UPI No. HHR38 DRAWN NC SKETCH BY WAY OF ILLUSTRATION ONLY "EXCEPTED LANDS" STREET WARWICK (9.00) ELECTRICITY INFRASTRUCTURE EASEMENT 5.20 WIDE (CREATED BY D34727) LOT 1 4047m² (8,124724) (SP.90II) (P.II6I23) (D.48459) (P.III045) (SP.90II) (0,18320) (D.30393) (P.II2642) (P.144320) (D.22002) ALLISON STREET (0.50u89) (D.48239) (SP.65916)

Page 1 of 1 Search Date: 27 Jul 2018 Search Time: 12:00 PM Volume Number: 161026 Revision Number: 02

PROPOSED RESIDENCE FOR: DANIEL & SARAH VAUTIN 7 ALLISON STREET,



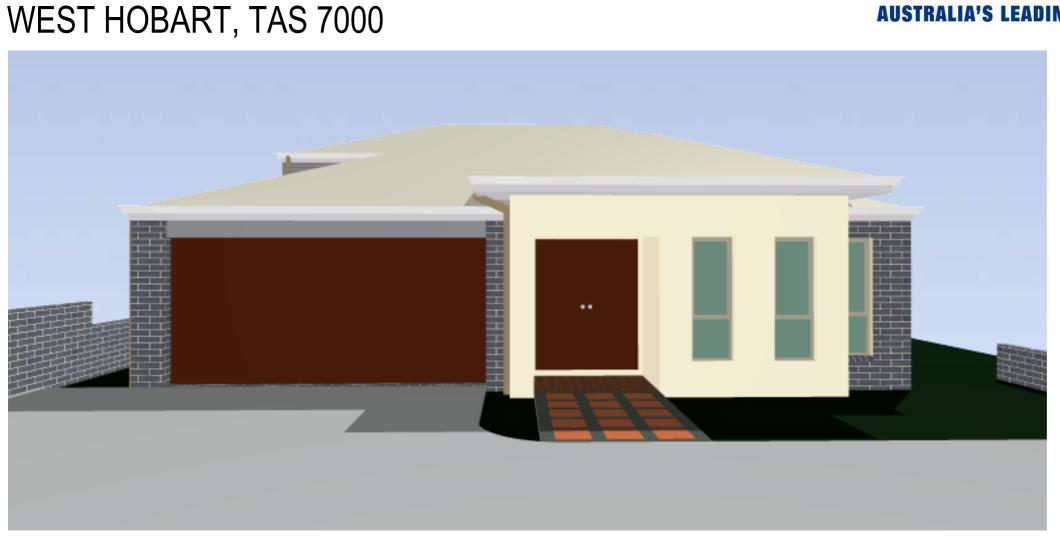

SHEET LIST					
SHEET NUMBER SHEET NAME SHEET NUMBER SHEET NAME					
00	COVER SHEET	03-1	ELEVATIONS SW & NW		
01-1	DEMOLITION PLAN	03-2	ELEVATIONS SE & NE		
01-2	SITE PLAN	04-1	SECTION 1		
01-3	TRAFFIC MANOEUVERING	04-2	SECTION 2		
01-4	SIGHT DISTANCE	05-1	SLAB LAYOUT		
01-5	SITE STORMWATER LAYOUT	05-2	BRICKWORK SETOUT		
01-6	SITE SEWER LAYOUT	05-3	ROOF PLAN		
01-7	SITE UTILITIES	06	PERSPECTIVES		
01-8	SHADOW DIAGRAM 1	07-1	ELECTRICAL PLANS		
01-9	SHADOW DIAGRAM 2	07-2	UPPER ELECTRICAL PLAN		
01-10	SHADOW DIAGRAM 3	08	KITCHEN DETAILS		
01-11	SHADOW DIAGRAM 4	09-1	WET AREA DETAILS		
02-1	GROUND FLOOR PLAN	09-2	WET AREA DETAILS		
02-2	UPPER FLOOR PLAN				


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Е	Council Amendments	29/05/18	
D	Council Amendments	05/03/18	
С	Council Amendments	23/02/18	
В	Working Drawings	20/02/18	
Α	Preliminary Drawings	13/02/18	
Rev	Amendment	Date	





	CLIENT	
	DATE/	
,	BUILDER	
т	DATE	

BASIX CERT. No.	SCALE	
PRELIM	DATE	22/06/18
PLAN	DRAWN	VN-HL
HILLGROVE 234	CHECKED	
TITLE	JOB No.	DWG No.
COVER SHEET	T.B.A.	00

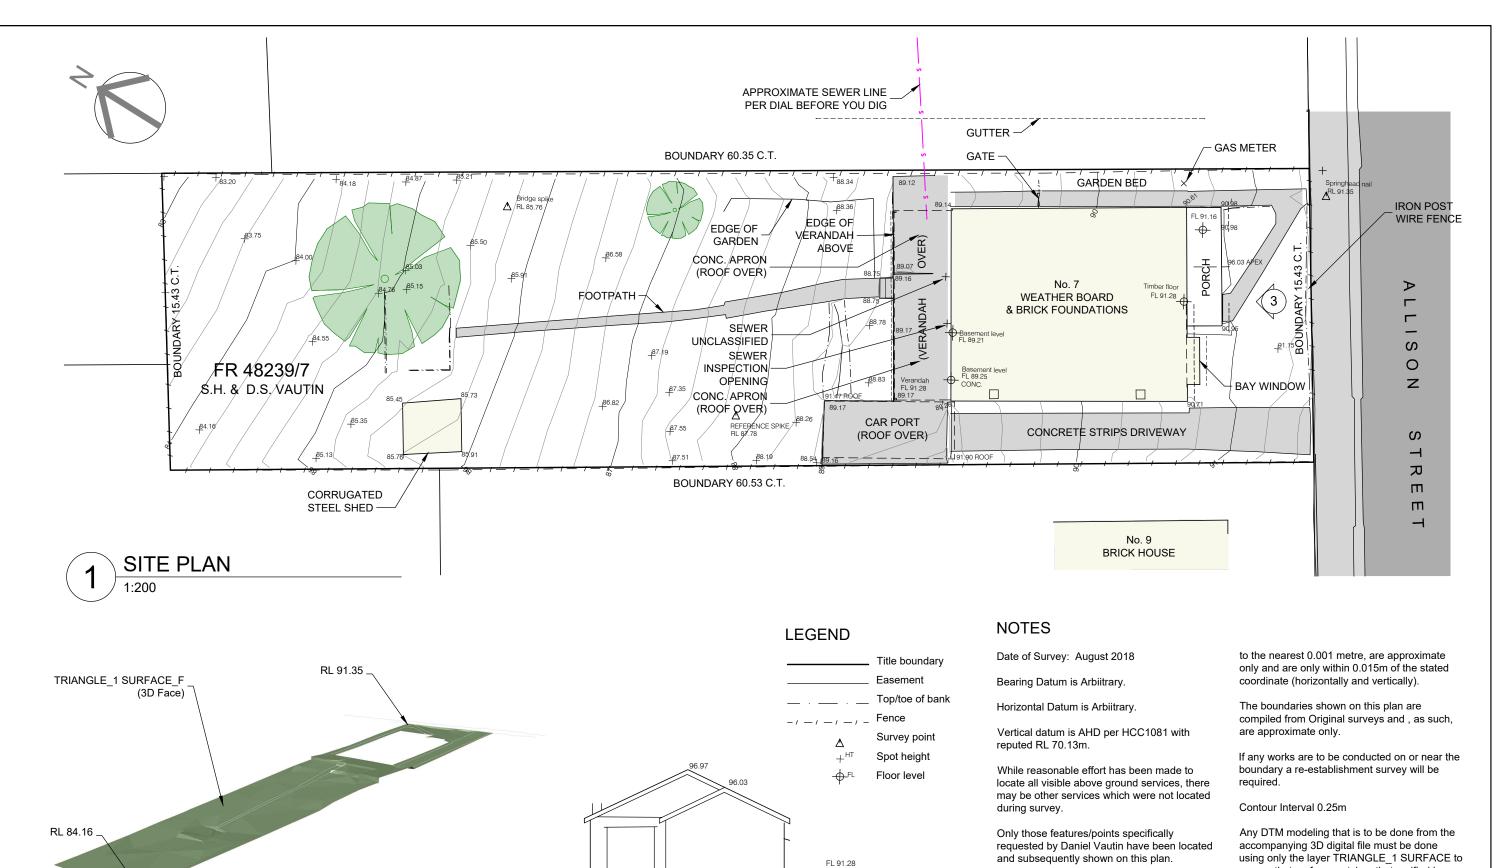

3D VIEW LOOKING SOUTH EAST

STREET Elevation 1:200

Prior to any demolition, excavation, final design or construction on this site, a comprehensive site investigation should be undertaken to locate all above and below ground service infrastructure.

All coordinates within this file, although stated

using only the layer TRIANGLE_1 SURFACE to ensure that surface matches that verified by PDA Surveyors. No responsibility is taken for the use or interpretation of this data in any other format.

Some feature levels are not shown on this plan for clarity. These can be found turned on in model space or on the OFF Levels layer.

E					SCALE:		
D							
С							
В					0 1 2	5	10m
Α					0 1 2	3	10111
REV	AMENDMENTS	DRAWN	DATE	APPR.			


	SURVEYOR	GEOCIVIL	
	DK	V978D	
	DRAWN	CHECKED	
)m	MK	MD	
,,,,,	DATE		
	14 AUGI	JST 2017	

DETAIL SURVEY PLAN 7 ALLISON STREET, WEST HOBART for D.S. & S.H. VAUTIN



127 Bathurst (Hobart, Tasmania, www.pda.com.au Also at: King. Launceston & Bu PHONE: +61 03 6234 3217 FAX: +61 03 6234 5085 EMAIL: pda.hbt@pda.com.au


Street	SCALE	PAPER		
7000 gston,	1: 200	(A3)		
Burnie	JOB NUMBER	DRAWING		
3217 5085 om.au	V978D	- 1		

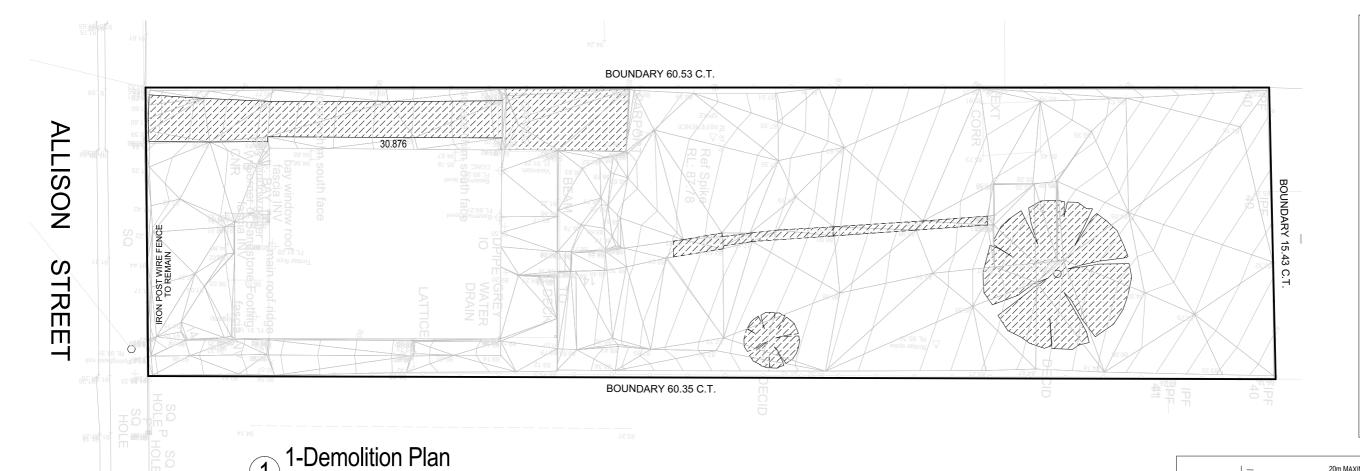


STANDARD NOTES

1. ALL WRITTEN DIMENSION TAKE PRECEDENCE OVER SCALE.

2. ALL ROOF BEAMS. LINTELS AND BRICKWORK ANGLES TO TRUSS/WALL FRAME MANUFACTURER'S SPECIFICATIONS AND ENGINEERS VERIFICATION. 3. WC DOORS TO COMPLY WITH BCA VOL 2 PT 3.8.3.3. 4. ALL WET AREAS TO BE COMPLETED IN ACCORDANCE WITH BCA VOL 2 PT 3.8.1. 5. ENGINEER DESIGNED - PREFABRICATED TIMBER ROOF TRUSSES AS PER MANUFACTURER'S SPECIFICATIONS. (600 CTS UNLESS NOTED OTHERWISE). 6. CONVENTIONAL FRAMING AS PER MANUFACTURER'S SPECIFICATIONS, U.N.O. 7. BUILDER & TRADES ARE TO CONFIRM ALL MEASUREMENTS, DETAILS & SPECIFICATIONS PRIOR TO SET-OUT BE ORDERING OF MATERIALS. 8. REPORT ANY ERRORS FOR CLARIFICATION/CORRECTION AS NO RESPONSIBILITY WILL BE TAKEN AFTER CONSTRUCTION HAS COMMENCED. 9. ALL ELECTRICAL APPLIANCE & PLUMBING SYMBOLS ARE DIAGRAMMATIC ONLY. REFER TO BUILDERS SPECIFICATION FOR DETAILS OF ALL FIXTURES. 10. SIZE AND LOCATION OF DOWNPIPES TO BE CONFIRMED ON SITE BY BUILDER. 11. ALL WORK TO BE CONSTRUCTED IN ACCORDANCE WITH THE BUILDING CODE OF AUSTRALIA AND RELEVANT TRADE AND TECHNICAL MANUALS.

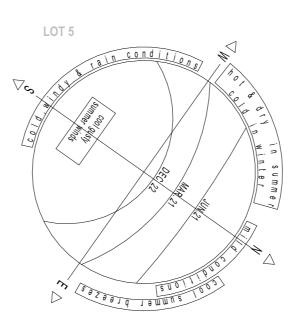

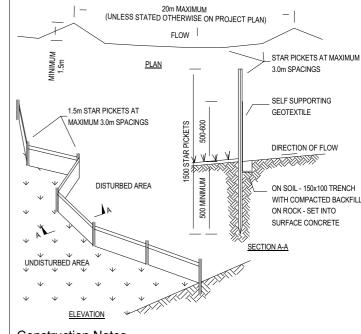

Construction Notes

- . Construct sediment fence as close as possible to parallel with the contours of the site.
- 2. Drive 1.5m long star pickets into ground, 3.0m apart.
- Dig a 150mm deep trench along the upslope line of the fence for the bottom of the fabric to be entrenched.
- 4. Backfill trench over base of fabric.
- Fix self-supporting geotextile to upslope side of posts with wire ties or as recommended by geotextile manufacturer.
- Join sections of fabric at support posts with a 150mm overlap.

SEDIMENT FENCE SD6-8

 F
 Council Amendments
 22/06/18

 E
 Council Amendments
 29/05/18

 D
 Council Amendments
 05/03/18

 C
 Council Amendments
 23/02/18

 B
 Working Drawings
 20/02/18

 A
 Preliminary Drawings
 13/02/18

Amendment

Date

Rev





	CLIENT	
	DATE/	
ND	BUILDER	
ENT	DATE/	

FOR DANIEL & SARAH VAUTIN

AT 7 ALLISON STREET,

WEST HOBART, TAS 7000


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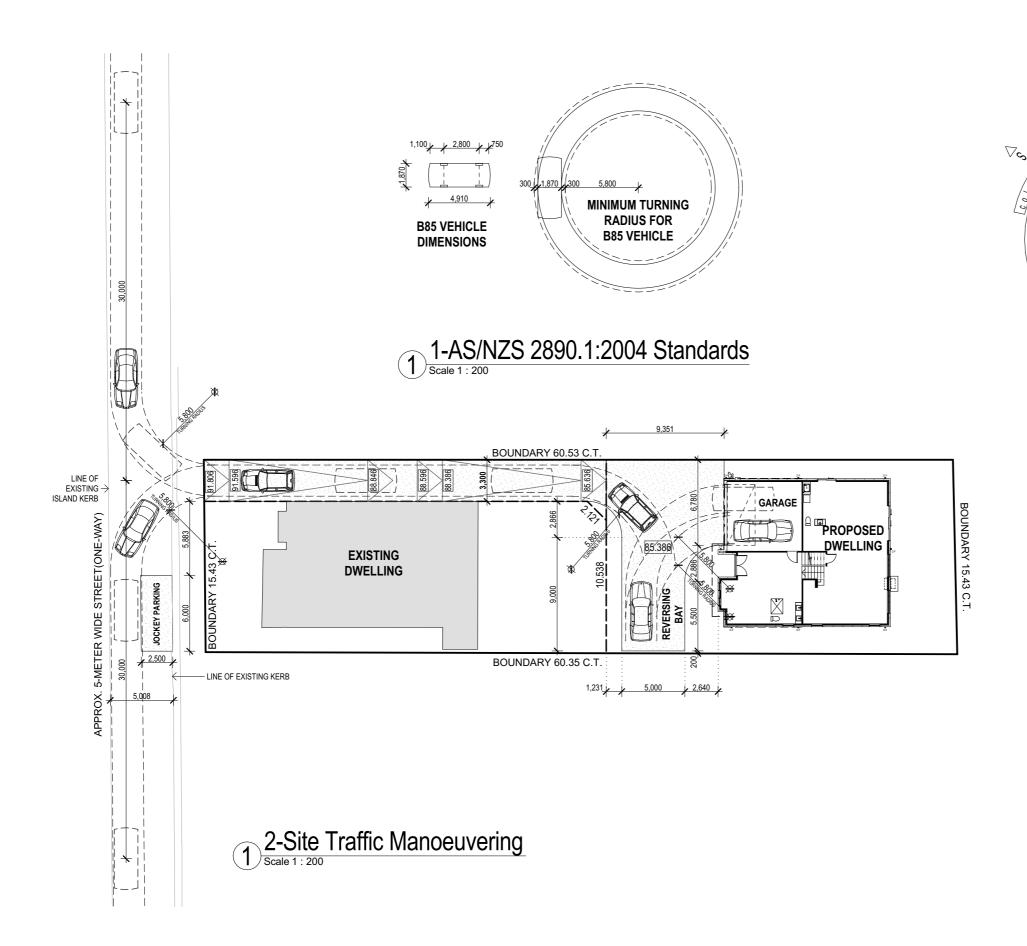
DENOTES EXISTING


STRUCTURE TO BE

DEMOLISHED

BASIX CERT. No.	SCALE	1:200
PRELIM	DATE	22/06/18
PLAN	DRAWN	VN-HL
HILLGROVE 234	CHECKED	
DEMOLITION PLAN	JOB No. T.B.A.	DWG No. 01-1
TITLE	JOB No.	



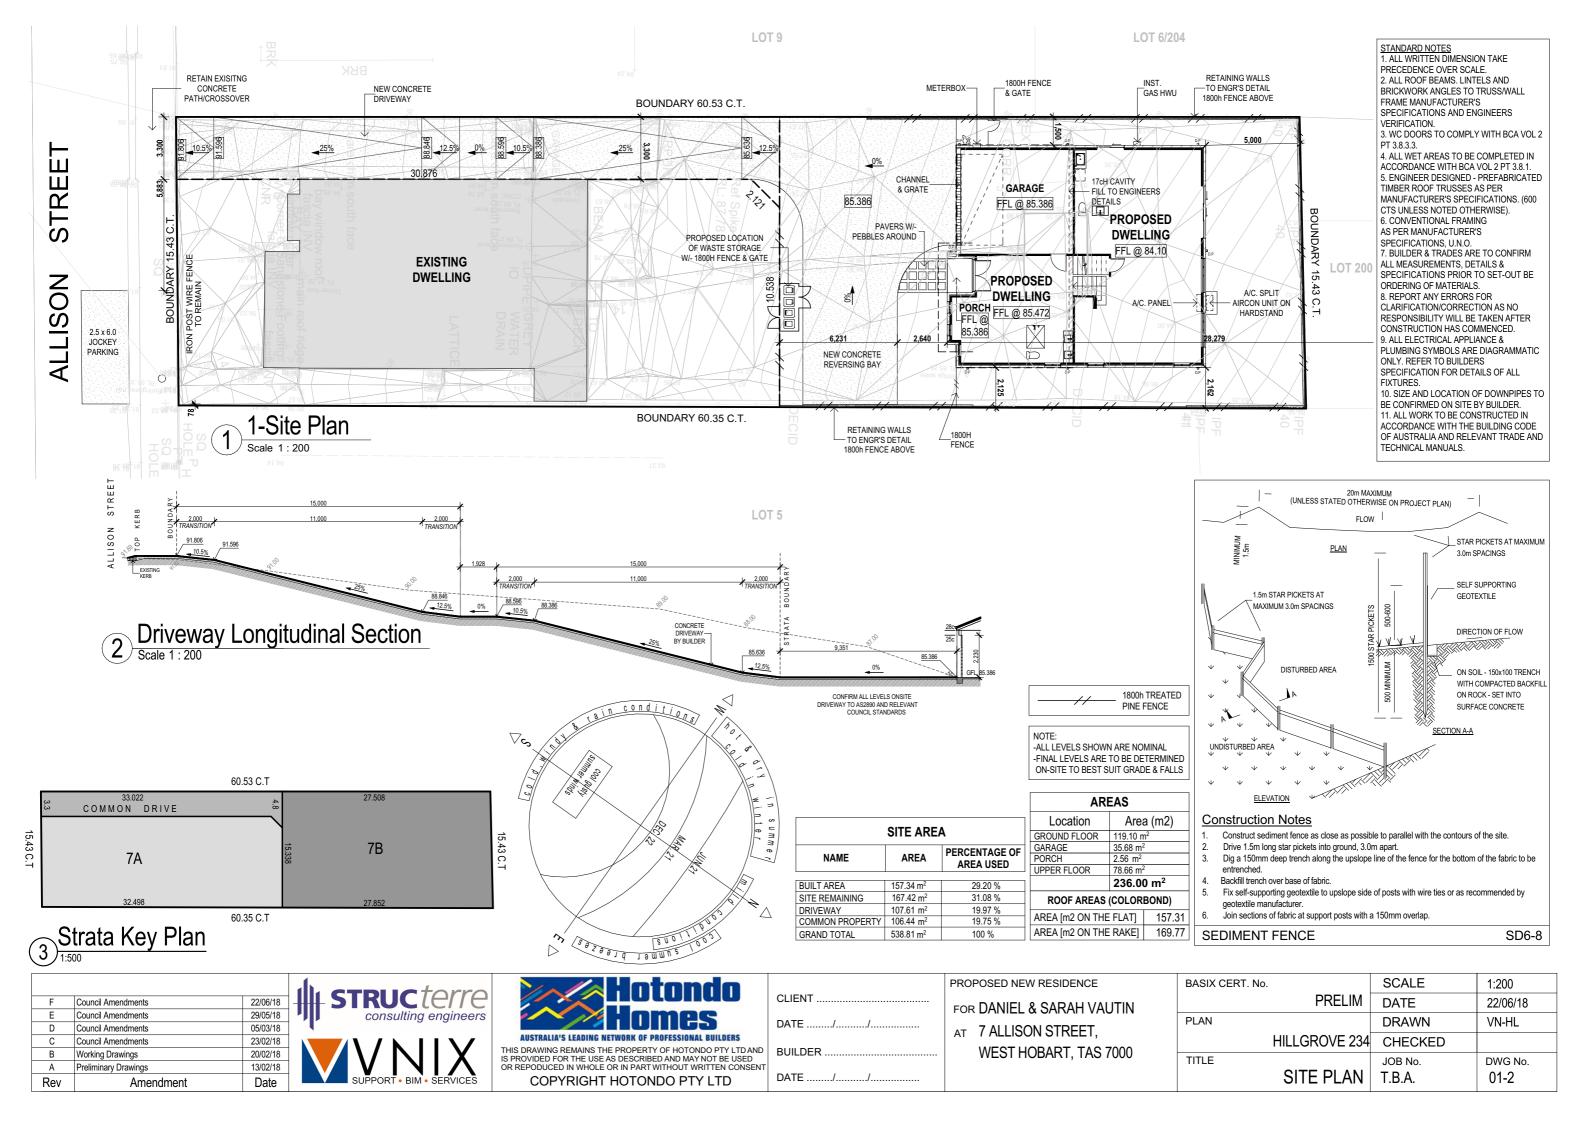

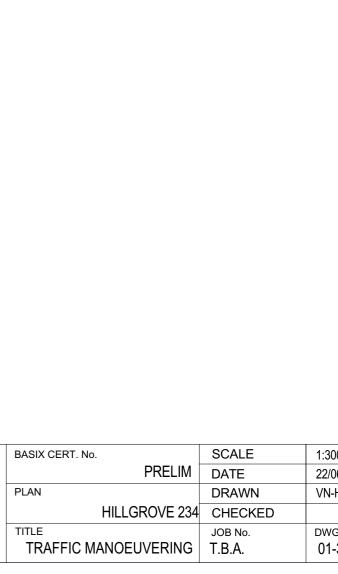


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Council Amendments	29/05/18
Council Amendments	05/03/18
Council Amendments	23/02/18
Working Drawings	20/02/18
Preliminary Drawings	13/02/18
Amendment	Date
	Council Amendments Council Amendments Council Amendments Working Drawings Preliminary Drawings





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	DATE/	
ND	BUILDER	
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BASIX CERT. No.	SCALE	1:300, 1:200
PRELIM	DATE	22/06/18
PLAN	DRAWN	VN-HL
HILLGROVE 234	CHECKED	
TITLE	JOB No.	DWG No.
TRAFFIC MANOEUVERING	T.B.A.	01-3

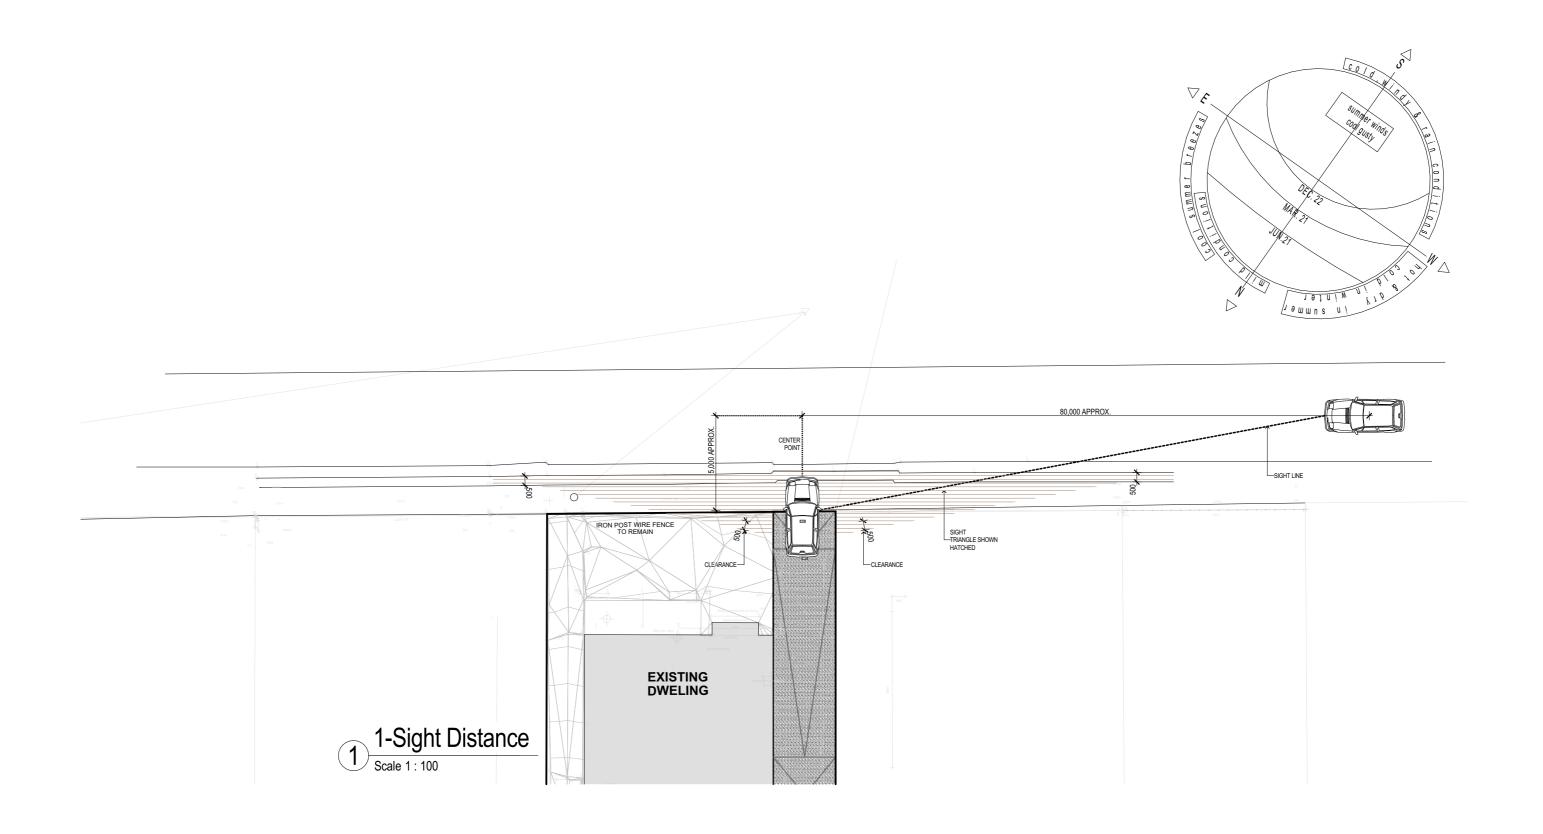


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Е	Council Amendments	29/05/18
D	Council Amendments	05/03/18
C	Council Amendments	23/02/18
В	Working Drawings	20/02/18
Α	Preliminary Drawings	13/02/18
Rev	Amendment	Date





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	DATE/
ID	BUILDER
NT	DATE/

BASIX C	ERT. No.	SCALE	1:200
	PRELIM	DATE	22/06/18
PLAN		DRAWN	VN-HL
	HILLGROVE 234	CHECKED	
TITLE		JOB No.	DWG No.
	SIGHT DISTANCE	T.B.A.	01-4

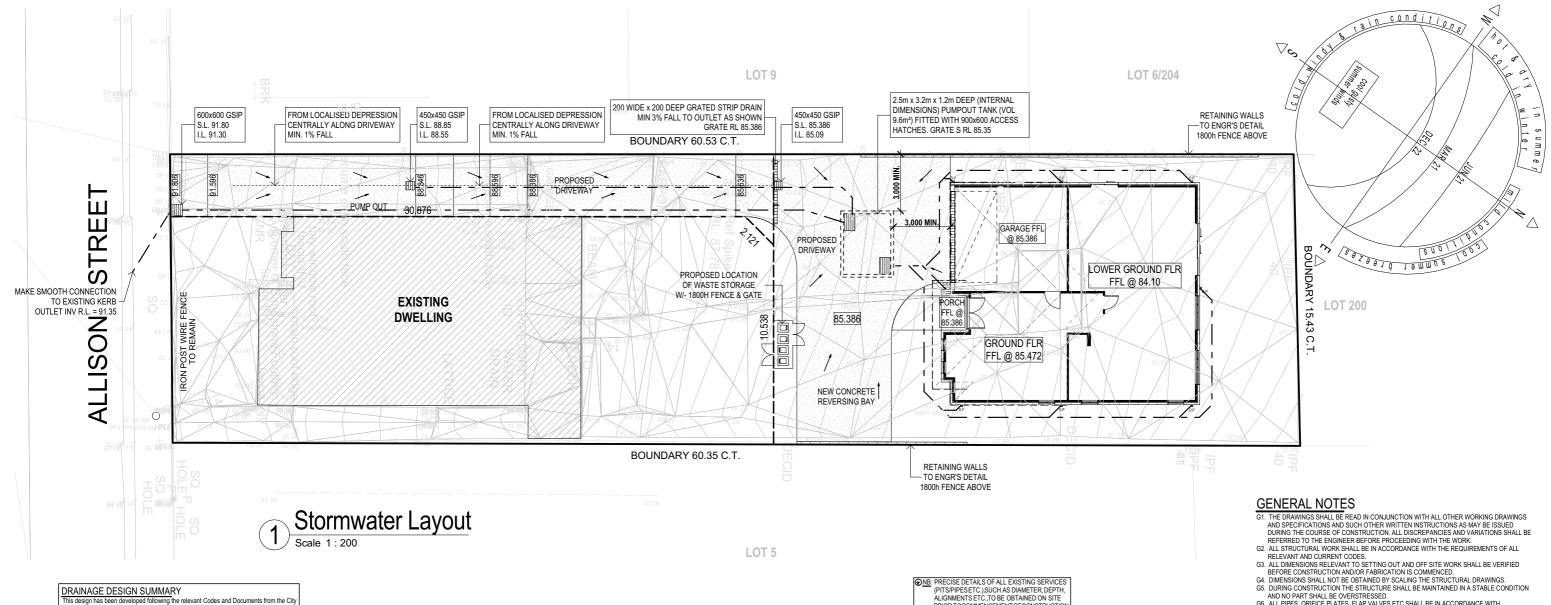

LOT 5

of Hobart Council. SITE CHARACTERISTICS Total Site area Current impervious are 15.3 m2 157.3 m2 Roof Area 214.0 m2 Total Impervious Area 371.4 m2 Rain Water Tank not required Due to the relative levels of the roof gutter levels of the development and the street gutter level a charged system for the discharge of stormwater is not viable. Hence a pump system is proposed, based on advice from Hobart Council Engineer. The runoff from the ppervious areas will be pumped to a boundary pit at the highest point along the boundary and then discharged via gravity to the kerb. Pump Storage Volume Contributing Area 371.4 m2 Design ARI 20Years Storm Period 2 Hours Rainfall Intensity 15.8mm/h Discharge rate Q = Rainfall Intensity (20yrrs, 2 hrs) x Catchment Area =1.7 l/s V = Rainfall Intensity (20yr, 2hrs) x Catchment Area x Time= 15.8mm/hr x 371.4 m2 x 2 hrs /olume pumped in 30 min = 3000 L


As per AS/NZS3500.3 Section 8 the combined effective storage shall comprise the volume

able to be pumped in 30min plus the wet well volume required to contain the design storm

= 11.74 - 3.0 =8.74m3

9.6 m3> 8.74 m3 Vol Reg'd: OK

DRAINAGE DESIGN SUMMARY

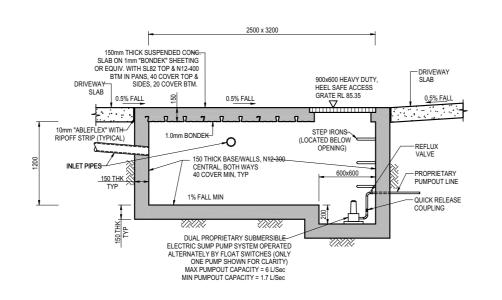

♠NB: PRECISE DETAILS OF ALL EXISTING SERVICES
(PITS/PIPESETC.),SUCH AS DIAMETER, DEPTH,
ALIGNMENTS ETC.,TO BE OBTAINED ON SITE PRIOR TO COMMENCEMENT OF CONSTRUCTION REFERANY DISCREPANCIES TO THIS OFFICE PRIOR TO PROCEEDING.

LEGEND

40.0 - EXISTING CONTOURS

____ 40.0 ___ - PROPOSED CONTOURS

DP• - PROPOSED DOWNPIPE (100x50/:90 U.N.O.-REFER DETAILS) - PROPOSED PIPE (SIZED AT CC STAGE)

- EXISTING PIPE

- DIRECTION OF FALL (1% MIN U.N.O.)

- PROPERTY BOUNDARY

- INSPECTION RISER/CLEANING EYE (DIA. TO MATCH PIPE) WITH SCREWCAP LID.

- EXISTING SPOT LEVEL

€N0.52 - PROPOSED SPOT LEVEL

- PROPOSED GRATED SURFACE INLET PIT (GSIP)

 \boxtimes - PROPOSED JUNCTION PIT (JP)

- PROPOSED OVERLAND FLOWPATH

- G6. ALL PIPES, ORIFICE PLATES, FLAP VALVES ETC SHALL BE IN ACCORDANCE WITH HYDRAULIC DRAWINGS.

CONCRETE NOTES

C1. ALL WORKMANSHIP AND MATERIALS SHALL BE IN ACCORDANCE WITH THE CURRENT EDITION OF AS 3600 AND OTHER RELEVANT CODES.

STORMWATER NOTES

ST1. ALL DRAINAGE PIPES TO BE SIZED/GRADED AT CC STAGE.
ST2. A CONTINUOUS SILT BARRIER FENCE IS TO BE PROVIDED ALONG LOWER BOUNDARIES FOR DURATION OF CONSTRUCTION - REFER DETAIL.

ST3. HAYBALE BARRIERS TO BE PROVIDED AROUND INLET PITS FOR DURATION OF CONSTRUCTION - REFER DETAIL.

ST4. DRAINAGE HAS BEEN DESIGNED IN ACCORDANCE WITH METHODS SET OUT IN 'AUSTRALIAN

514. URAINAGE HAS BEEN DESIGNED IN ACCORDANCE WITH METHOUS SET OUT IN AGSTRALIAN RAINFALL AND RUNOFF (1987).

STS. ALL NECESSARY WORK INVOLVED IN THE CREATION OF EASEMENT/RIGHT OF CONNECTION TO ANY EXISTING SERVICES AND

EROSION CONTROL NOTES

- E1. EROSION CONTROL MEASURES TO BE IN PLACE PRIOR TO COMMENCEMENT OF ANY CONSTRUCTION WORK.

 E2. REHABILITATION INCLUDES COMPLETION OF ALL CONSTRUCTION WORK AND LANDSCAPING, SEEDING OR TURFING OF ALL BATTERS AND FILL AREAS.

 E3. A PROGRAM OF PROGRESSIVE REHABILITATION SHOULD BE IMPLEMENTED TO MINIMISE EPOSION.

- EROSION.

 4. TOP SOIL STOCKPILES TO BE SOWN IF LEFT UNDISTURBED FOR MORE THAN FOUR WEEKS.

 5. THE NEAREST COUNCIL PIT SHALL BE PROTECTED WITH SAND BAG SEDIMENT TRAPS AND TRAFFIC BARRIERS ACCORDING TO AS 17423 1985.

 6. ONLY ONE CONSTRUCTION ENTRY/EXIT SHALL BE USED DURING CONSTRUCTION.

 6. DURING WET WEATHER MUD IS TO BE HOSED OFF ON THE RAMP PRIOR TO VEHICLES LEAVING THE SITE
- LEAVING THE SITE E8. EXTRA HAY BALES TO BE STORED AT SITE FOR THE USE OF ANY OPEN TRENCHES,
- PITS FTC
- E9. SEDIMENT TRAPS SHALL BE INSPECTED AFTER EACH STORM. CLEAN OR REPLACE IF NECESSARY.
- E10. BALE BARRIERS TO BE REMOVED FOLLOWING COMPLETION OF ALL CONSTRUCTION WORKS, PAVEMENT AND LANDSCAPING AREAS, WITH COUNCIL APPROVAL.

Rev	Amendment	Date
Α	Preliminary Drawings	13/02/18
В	Working Drawings	20/02/18
С	Council Amendments	23/02/18
D	Council Amendments	05/03/18
Е	Council Amendments	29/05/18
F	Council Amendments	22/06/18

Final Volume required

/olume Provided



Hotondo
Homes
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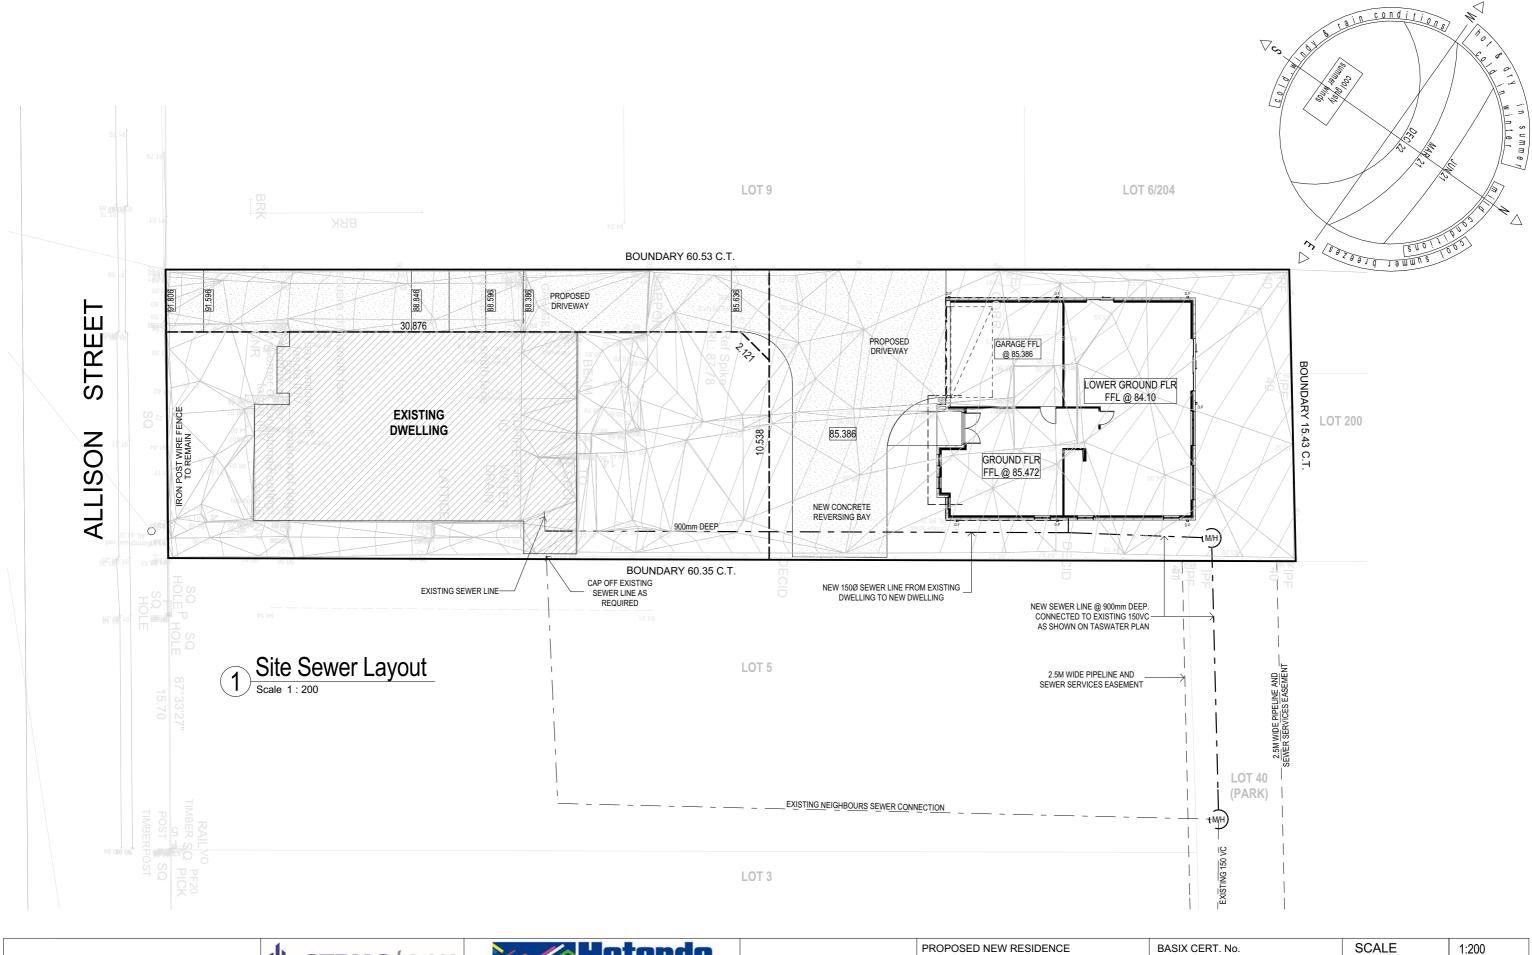
BELOW GROUND PUMPOUT TANK - SECTION A

DATE/	1
	1
BUILDER	
DATE/	

CLIENT

PRO	POSED NEW RESIDENCE
FOR	DANIEL & SARAH VAUTIN
AT	7 ALLISON STREET,
	WEST HOBART, TAS 7000

BASIX CERT. No.	SCALE	1:200
PRELIM	DATE	22/06/18
PLAN	DRAWN	VN-HL
HILLGROVE 234	CHECKED	
TITLESITE STORMWATER	JOB No. T.B.A.	DWG No. 01-5
LAIOUI		



F	Council Amendments	22/06/18
E	Council Amendments	29/05/18
D	Council Amendments	05/03/18
С	Council Amendments	23/02/18
В	Working Drawings	20/02/18
Α	Preliminary Drawings	13/02/18
Rev	Amendment	Date




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	DATE/
ND	BUILDER
NT	DATE/

FOR DANIEL & SARAH VAUTIN
AT 7 ALLISON STREET,
WEST HOBART, TAS 7000

SCALE	1:200
DATE	22/06/18
DRAWN	VN-HL
CHECKED	
JOB No. T.B.A.	DWG No. 01-6
	DATE DRAWN CHECKED JOB No.

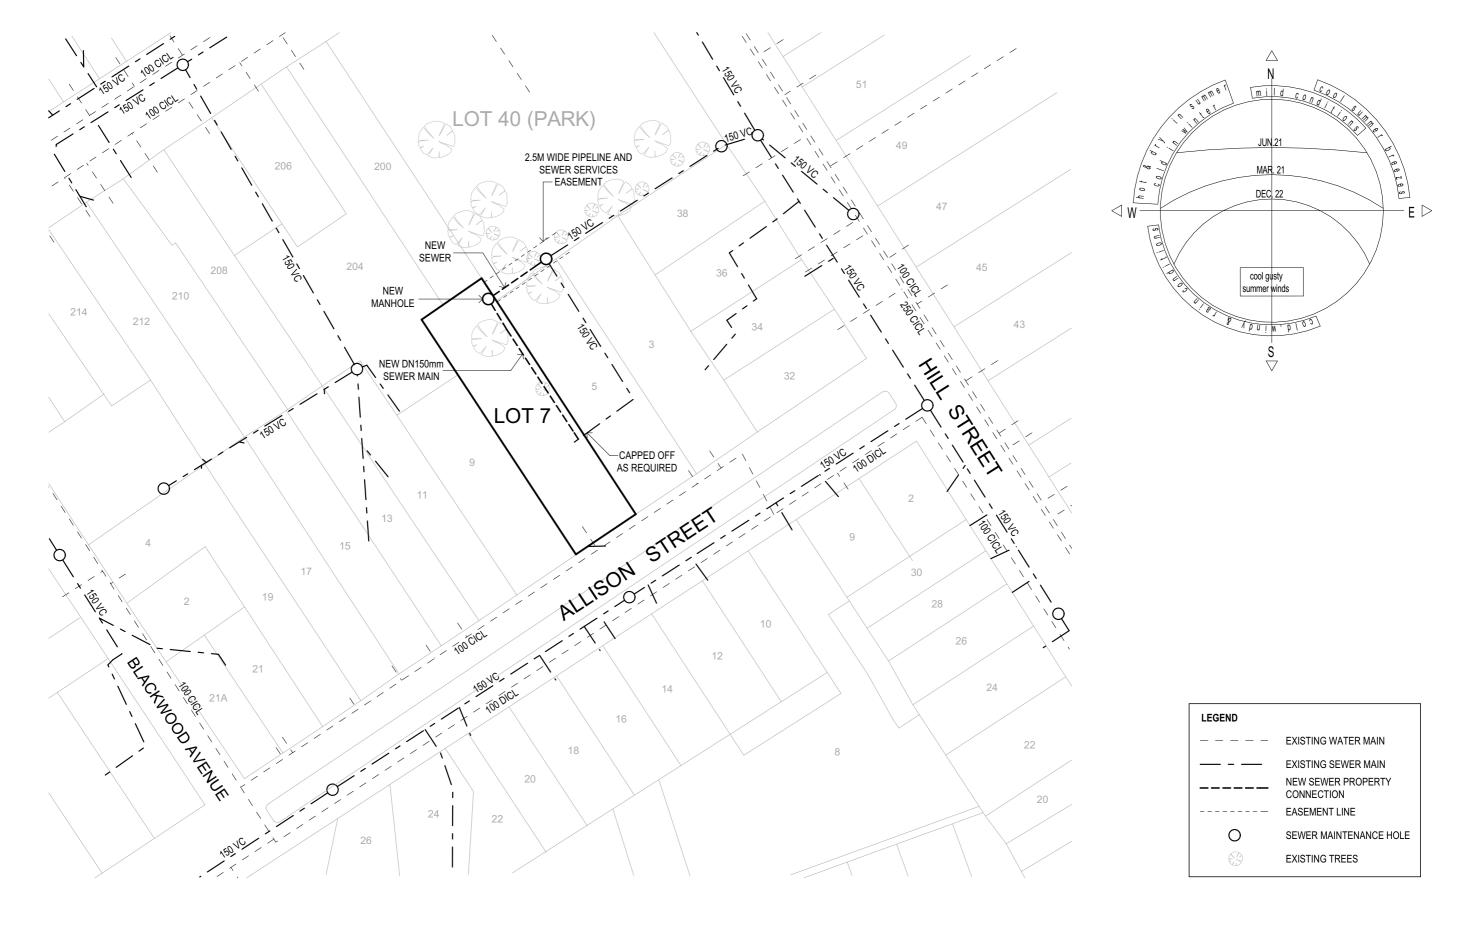


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В	Working Drawings	20/02/18
Α	Preliminary Drawings	13/02/18
Rev	Amendment	Date






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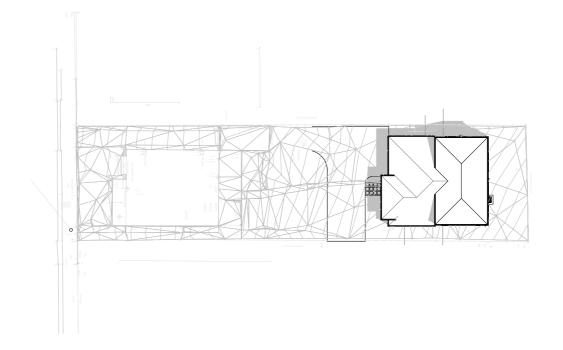
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	PRELIM	DATE	22/06/18
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	HILLGROVE 234	CHECKED	
TITLE	SITE UTILITIES	JOB No. T.B.A.	DWG No. 01-7



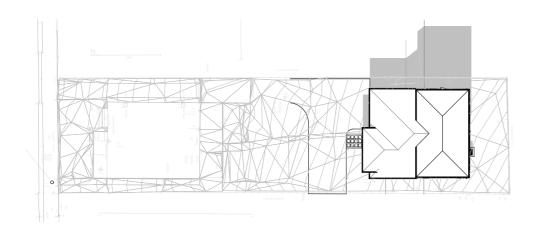



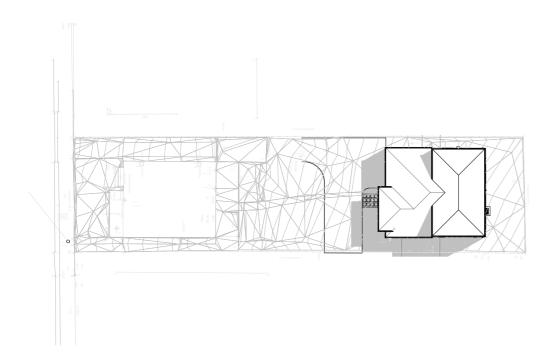






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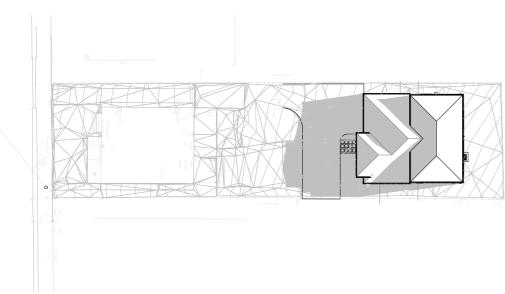


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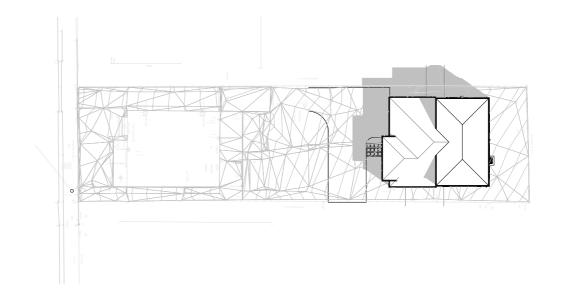
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PRELIM	DATE	22/06/18
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HILLGROVE 234	CHECKED	
SHADOW DIAGRAM 1	JOB No. T.B.A.	DWG No. 01-8







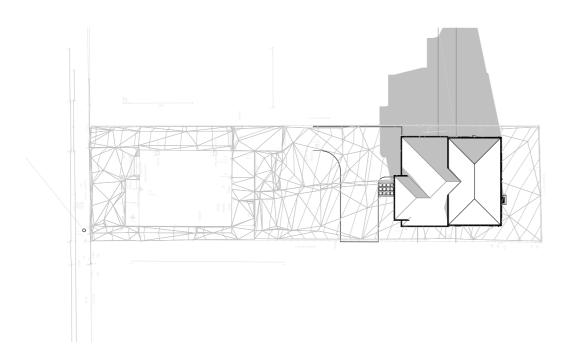






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ts 23/02/18
its 05/03/18
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its 22/06/18




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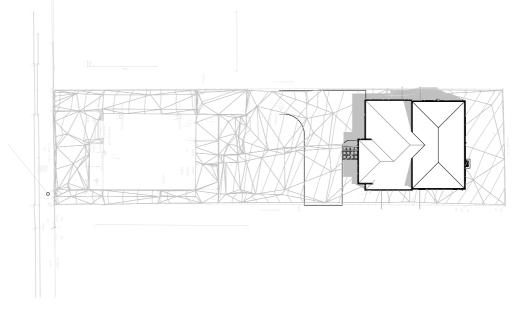
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IT	DATE / /


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PRELIM	DATE	22/06/18
PLAN	DRAWN	VN-HL
HILLGROVE 234	CHECKED	
SHADOW DIAGRAM 2	JOB No. T.B.A.	DWG No. 01-9



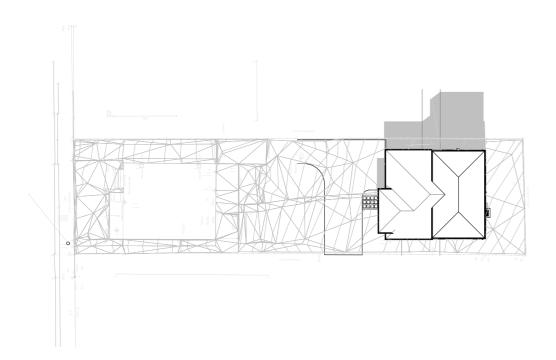



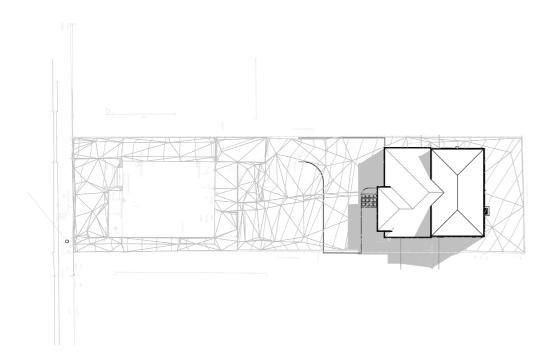

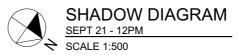




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Е	Council Amendments	29/05/18
D	Council Amendments	05/03/18
С	Council Amendments	23/02/18
В	Working Drawings	20/02/18
Α	Preliminary Drawings	13/02/18
Rev	Amendment	Date







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D	BUILDER
IT	DATE / /

BASIX CERT. No.	SCALE	1:500
PRELIM	DATE	22/06/18
PLAN	DRAWN	VN-HL
HILLGROVE 234	CHECKED	
TITLE	JOB No.	DWG No.
SHADOW DIAGRAM 3	T.B.A.	01-10

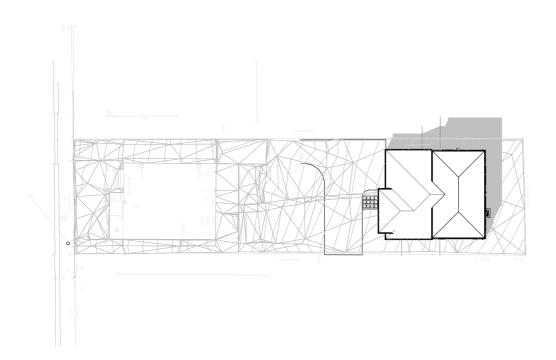



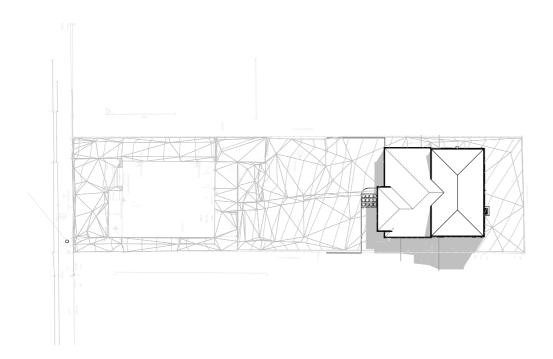

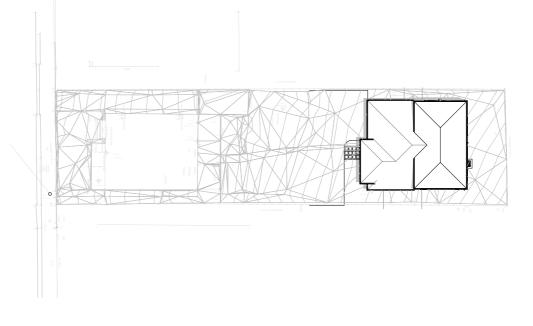






F	Council Amendments	22/06/18
Е	Council Amendments	29/05/18
D	Council Amendments	05/03/18
С	Council Amendments	23/02/18
В	Working Drawings	20/02/18
Α	Preliminary Drawings	13/02/18
Rev	Amendment	Date





CLIENT
DATE/
BUILDER
DATE / /

BASIX CERT. No.	SCALE	1:500
PRELIM	DATE	22/06/18
PLAN	DRAWN	VN-HL
HILLGROVE 234	CHECKED	
SHADOW DIAGRAM 4	JOB No. T.B.A.	DWG No. 01-11

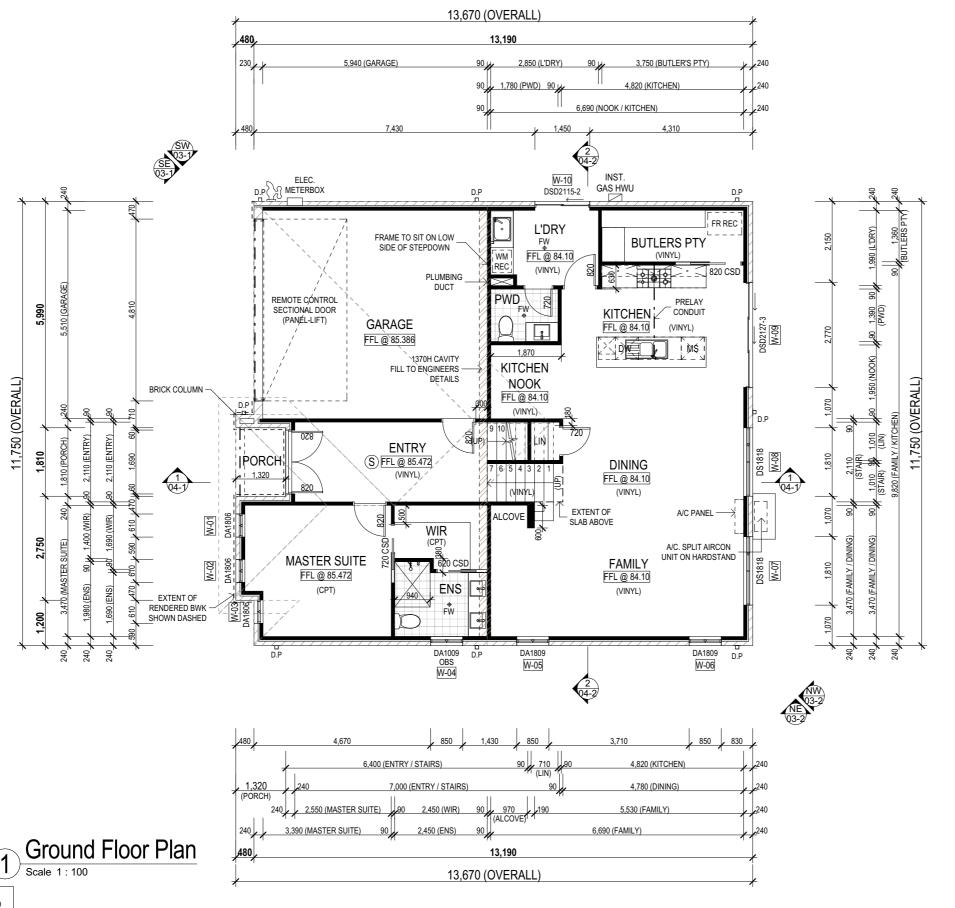

LOCATED 350mm FROM THE CORNER OF THE EXTERNAL WALL TO CENTRE OF THE DOWNPIPE. AREA [m2 ON THE RAKE] 169.77 ALL WRITTEN DIMENSIONS TAKE PRECEDENCE OVER SCALE BUILDER TO VERIEV ALL DIMENSIONS PRIOR TO COMMENCING CONSTRUCTION, NOTIFY DESIGNER OF ANY DISCREPANCIES BEFORE PROCEEDING DRAWINGS SHALL NOT BE USED FOR CONSTRUCTION PURPOSES UNTIL ISSUED FOR CONSTRUCTION.

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CLIENT DATE BUILDER DATE .

FOR DANIEL & SARAH VAUTIN AT 7 ALLISON STREET. WEST HOBART, TAS 7000

PROPOSED NEW RESIDENCE

BASIX CERT. No.	SCALE	1:100
PREI	LIM DATE	22/06/18
PLAN	DRAWN	VN-HL
HILLGROVE	234 CHECKED	
TITLE	JOB No.	DWG No.
FLOOR PL	AN T.B.A.	02-1

GRAND TOTAL 236.00 m²

AREAS

Area (m2)

Location

GROUND FLOOR

GARAGE

PORCH UPPER FLOOR

ROOF AREAS (COLORBOND) AREA [m2 ON THE FLAT] 157.31

78.66

WC TOILET CEILING FAN LIGHT COMBO

Window List

Description

AWNING WINDOW

AWNING WINDOW

AWNING WINDOW

AWNING WINDOW

AWNING WINDOW

AWNING WINDOW

SLIDING WINDOW

SLIDING WINDOW

STACKER DOOR

SLIDING DOOR

SLIDING WINDOW

SLIDING WINDOW

SLIDING WINDOW

SLIDING WINDOW

SLIDING WINDOW

AWNING WINDOW

(GROUND FLOOR) ROOM SCHEDULE

Area (m2)

4 41

3.84

32.73 10.74

18.90

137.63 m²

LEGEND

TOWEL RAIL (DOUBLE) / (SINGLE)

SOLAR HOT WATER SYSTEM (GAS BOOST)

CEILING FAN

RECESSED ELECTRICAL METER BOX

DOWNPIPE & SPREADER

ROBE HOOK @ 1750

LAMINATE FLOORING

FINISHED FLOOR LEVEL

GARAGE FLOOR LEVEL

HARDWOOD DECKING

700mm SHOWER RAII

OVERHEAD CUPBOARDS

RANGEHOOD (DUCTED)

TOWEL RING @ 1100

TRANSLUCENT GLASS

TOILET ROLL HOLDER

WASHING MACHINE

DOOR WITH PRIVACY LOCK

MIXER

SETDOWN

TAP

FLOORWASTE SERVICES STACK SPOUT

CARPET CERAMIC TILES

COOK TOP

DOWNPIPE

Area

1.10

1.10

1.10

0.87

1.53

1.53

3.26

3.26

5.94

3.11

1.86

1.86

1.24

1.24

1.86

0.63

31.49 m²

Width

610

610

610

850

850

850

1,810

1,810

2.770

1.450

1.810

1.810

850

850

1.810

610

Location

MASTER SUIT

ENTRY

KITCHEN

DINING FAMILY

KITCHEN NOC

Grand Total

C/T

DP

FL

GFL

MB

MX

RAIL

720 PL

R/H

S/D

FW

Trns

TRH

WM

DPS

DTR/TR

Height

1,800

1,800

1,800

1,029

1,800

1,800

1,800

1,800

2,143

2,143

1,029

1.029

1,457

1 457

1,029

1,029

W-01

W-02

W-03

W-04

W-05

W-06

W-07

W-08

W-09

W-10

W-11

W-12

W-13

W-14

W-15

W-16


Grand Total : 16

NOTE: DOWNPIPES TO BUILDING CORNERS ARE TO BE

NOTES: WINDOW OPENINGS SHOWN NOMINAL AND TO BE CONFIRMED WITH WINDOW MANUFACTURER

F	Council Amendments	22/06/18		
E	Council Amendments 29/05/18			
D	Council Amendments	05/03/18		
С	Council Amendments	23/02/18		
В	Working Drawings	20/02/18		
Α	Preliminary Drawings	13/02/18		
Rev	Amendment	Date		

STRUC*terre* consulting engineers

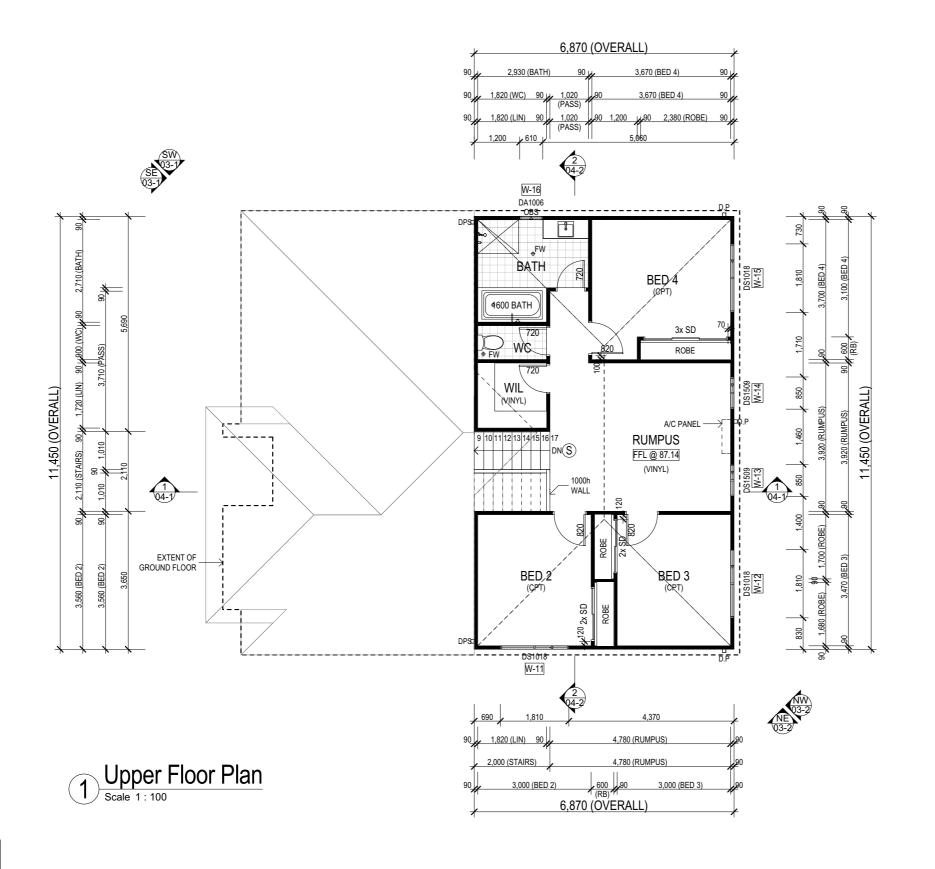

V(0	1	S:	

WINDOW OPENINGS SHOWN NOMINAL AND TO BE CONFIRMED WITH WINDOW MANUFACTURER

• FC SHEETING OVER EXTERNAL SLIDING DOORS

AND WINDOWS (NO BRICKWORK OVER)

Council Amendments 22/06/18 Council Amendments 29/05/18 05/03/18 D Council Amendments Council Amendments 23/02/18 Working Drawings 20/02/18 Preliminary Drawings 13/02/18 Rev Amendment Date



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CLIENT DATE BUILDER DATE ..

PROPOSED NEW RESIDENCE FOR DANIEL & SARAH VAUTIN AT 7 ALLISON STREET, WEST HOBART, TAS 7000

Window List				
ID	Height	Width	Description	Area
W-01	1,800	610	AWNING WINDOW	1.10
W-02	1,800	610	AWNING WINDOW	1.10
W-03	1,800	610	AWNING WINDOW	1.10
W-04	1,029	850	AWNING WINDOW	0.87
W-05	1,800	850	AWNING WINDOW	1.53
W-06	1,800	850	AWNING WINDOW	1.53
W-07	1,800	1,810	SLIDING WINDOW	3.26
W-08	1,800	1,810	SLIDING WINDOW	3.26
W-09	2,143	2,770	STACKER DOOR	5.94
W-10	2,143	1,450	SLIDING DOOR	3.11
W-11	1,029	1,810	SLIDING WINDOW	1.86
W-12	1,029	1,810	SLIDING WINDOW	1.86
W-13	1,457	850	SLIDING WINDOW	1.24
W-14	1,457	850	SLIDING WINDOW	1.24
W-15	1,029	1,810	SLIDING WINDOW	1.86
W-16	1,029	610	AWNING WINDOW	0.63
Grand Total : 16 31.49 m ²				

(FIRST FLOOR) ROOM SCHEDULE				
Location	Area (m2)			
BED 2	10.41			
BED 3	10.41			
BATH	6.93			
BED 4	13.58			
WC	1.64			
RUMPUS	18.74			
PASS	1.94			
WIL	3.13			
STAIRS	4.22			
Grand Total	71.00 m ²			

	LEGEND				
	CPT	CARPET			
	CT	CERAMIC TILES			
	C/T	COOK TOP			
	DP	DOWNPIPE			
	DPS	DOWNPIPE & SPREADER			
	DTR/TR	TOWEL RAIL (DOUBLE) / (SINGLE)			
	HK	ROBE HOOK @ 1750			
	FT	LAMINATE FLOORING			
	FL	FINISHED FLOOR LEVEL			
	GFL	GARAGE FLOOR LEVEL			
	HWD	HARDWOOD DECKING			
	HWS	SOLAR HOT WATER SYSTEM (GAS BOOST)			
	MB	RECESSED ELECTRICAL METER BOX			
	RAIL	700mm SHOWER RAIL			
	MX MIXER				
	O/H	OVERHEAD CUPBOARDS			
	720 PL	DOOR WITH PRIVACY LOCK			
	R/H	RANGEHOOD (DUCTED)			
	S/D SETDOWN				
	FW	FLOORWASTE			
	ST	SERVICES STACK			
	S	SPOUT			
	T	TAP			
_	RT	TOWEL RING @ 1100			
	Trns	TRANSLUCENT GLASS			
\neg	TRH	TOILET ROLL HOLDER			
\neg	WM	WASHING MACHINE			
	WC	TOILET			
		CEILING FAN LIGHT COMBO			

AREAS

ROOF AREAS (COLORBOND)

Area (m2)

35 68 m²

2.56 m²

78.66 m²

236.00 m²

Location

GARAGE

UPPER FLOOR

GRAND TOTAL

PORCH

GROUND FLOOR 119.10 m²

AREA [m2 ON THE FLAT]


AREA [m2 ON THE RAKE]


NOTE: DOWNPIPES TO BUILDING CORNERS ARE TO BE 157.31 169.77 LOCATED 350mm FROM THE CORNER OF THE EXTERNAL WALL TO CENTRE OF THE DOWNPIPE.

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BASIX CERT. No.	SCALE	1:100, 1:1
PRELIM	DATE	22/06/18
PLAN	DRAWN	VN-HL
HILLGROVE 234	CHECKED	
UPPER FLOOR PLAN	JOB No. T.B.A.	DWG No. 02-2

NOTE:
UPPER FLOOR BEDROOM WINDOWS
MUST HAVE 125mm MAX RESTRICTED
OPENING OR FITTED WITH SUITABLE
SCREEN (IF OPENING SILL UNDER 1700 AFL)



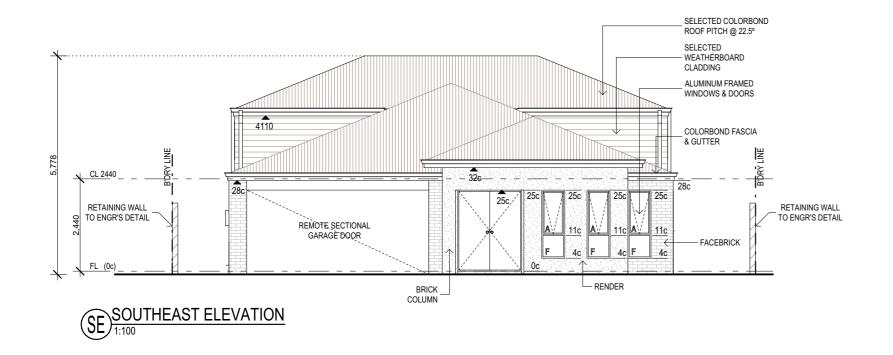

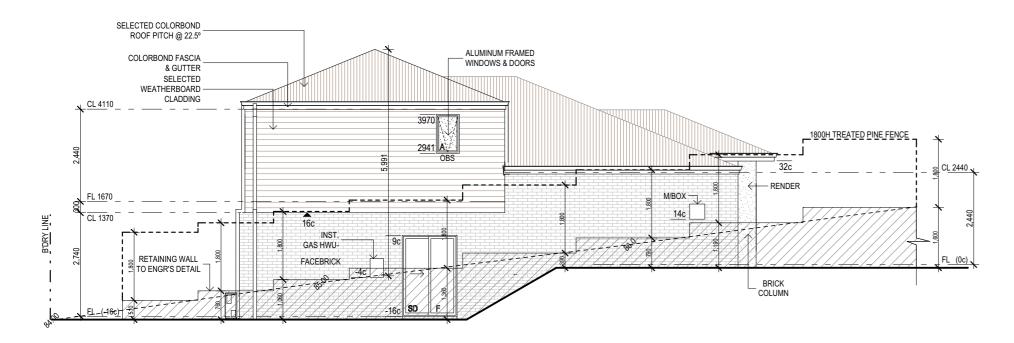SW) SOUTHWEST ELEVATION 1:100

F	Council Amendments	22/06/18
E	Council Amendments	29/05/18
D	Council Amendments	05/03/18
С	Council Amendments	23/02/18
В	Working Drawings	20/02/18
Α	Preliminary Drawings	13/02/18
Rev	Amendment	Date




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	PROPOSED NEW RESIDENCE
CLIENT	FOR DANIEL & SARAH VAUTIN
DATE/	AT 7 ALLISON STREET,
BUILDER	WEST HOBART, TAS 7000
DATE/	

BASIX CERT. No.	SCALE	1:100
PRELIM	DATE	22/06/18
PLAN	DRAWN	VN-HL
HILLGROVE 234	CHECKED	
ELEVATIONS SW & NW	JOB No. T.B.A.	DWG No. 03-1

NOTE:
UPPER FLOOR BEDROOM WINDOWS
MUST HAVE 125mm MAX RESTRICTED
OPENING OR FITTED WITH SUITABLE
SCREEN (IF OPENING SILL UNDER 1700 AFL)



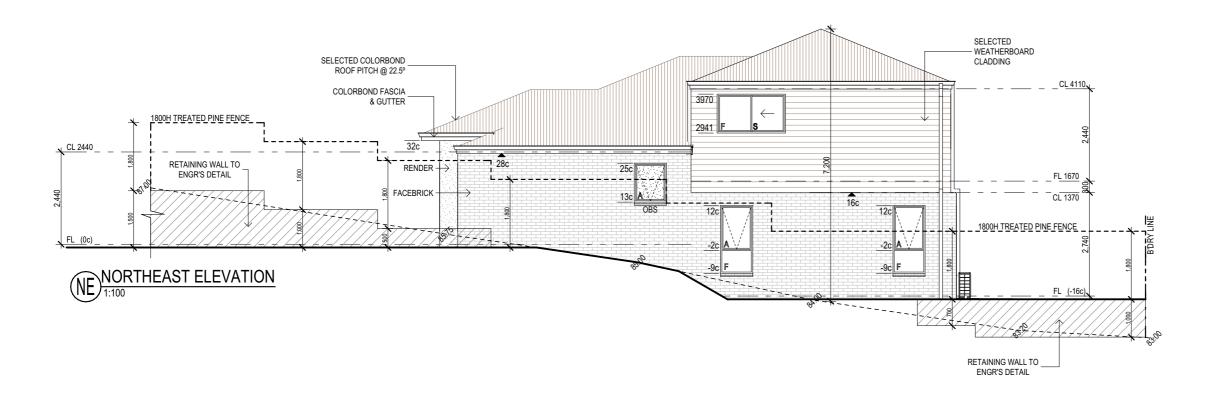

NORTHWEST ELEVATION 1:100

F	Council Amendments	22/06/18
E	Council Amendments	29/05/18
D	Council Amendments	05/03/18
С	Council Amendments	23/02/18
В	Working Drawings	20/02/18
Α	Preliminary Drawings	13/02/18
Rev	Amendment	Date



Hotondo
Homes
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	PROPOSED NEW RESIDENCE
CLIENT	FOR DANIEL & SARAH VAUTIN
DATE/	AT 7 ALLISON STREET,
BUILDER	WEST HOBART, TAS 7000
DATE/	

BASIX CERT. No.	SCALE	1:100
PRELIM	DATE	22/06/18
PLAN	DRAWN	VN-HL
HILLGROVE 234	CHECKED	
ELEVATIONS SE & NE	JOB No. T.B.A.	DWG No. 03-2

GENERAL NOTES

ARCHITECTURAL DRAWINGS TO BE READ IN CONJUNCTION WITH STRUCTURAL ENGINEERS DRAWINGS AND ALL OTHER RELEVANT CONSULTANTS DRAWINGS.

ALL DIMENSIONS TO BE VERIFIED BEFORE ANY WORK OR FABRICATION COMMENCES.

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ALL WORKS TO BE CARRIED OUT IN ACCORDANCE WITH THE RELEVANT CURRENT AUSTRALIAN STANDARDS AND THE BUILDING CODE OF AUSTRALIA UNLESS OTHERWISE SPECIETE

TIMBER FRAMINGTO BE IN ACCORDANCE WITH AS1684. NATIONAL TIMBER FRAMING CODE

SUB-FLOOR VENTILATION TO COMPLY WITH PART 3.4.1 BCA VOL. TWO

WHERE ROOF TRUSSES ARE NOMINATED DESIGN & SPECIFICATION TO BE BY MANUFACTURER.

BALUSTRADES TO COMPLY WITH BCA PART 3.9.2

POOL SAFETY FENCE TO COMPLY WIT AS1926.1 & SWIMMING POOLS ACT

INSTALLATION OF SMOKE DETECTORS TO COMPLY WITH AS3786.

PLUMBING & DRAINAGE SYSTEMS TO COMPLY

TERMITE MANAGEMENT SYSTEMS TO COMPLY WITH AS3660.

CONCRETE CONSTRUCTION TO BE IN ACCORDANCE WITH AS3600.

MASONRY CONSTRUCTION TO BE IN ACCORDANCE WITH AS3700.

DAMP-PROOF COURSE & FLASHINGS TO BE IN

UNPLASTICISED PVC (UPVC) DOWNPIPE & FITTINGS FOR RAINWATER TO COMPLY WITH AS1273

INSTALLATION OF SHEET ROOF & WALL CLADDING TO COMPLY WITH AS1273


ALL PEDESTRIAN SURFACES TO COMPLY WITH AS/NZS3661 SLIP RESISTANCE


GLASS TO BE SELECTED & INSTALLED IN ACCORDANCE WITH AS1288 & AS 2047.

WATERPROOFING OF WET AREAS TO COMPLY WITH AS3740

ELECTRICAL INSTALLATIONS TO COMPLY WITH

PLEASE NOTE: THE STANDARDS REFERENCED IN THE TABLE ARE THE RELEVANT VERSION ADOPTED BY THE BCA AT THE TIME THE CONSTRUCTION CERTIFICATE OR COMPLYING DEVELOPEMNT CERTIFICATE APPLICATION WAS LODGED.

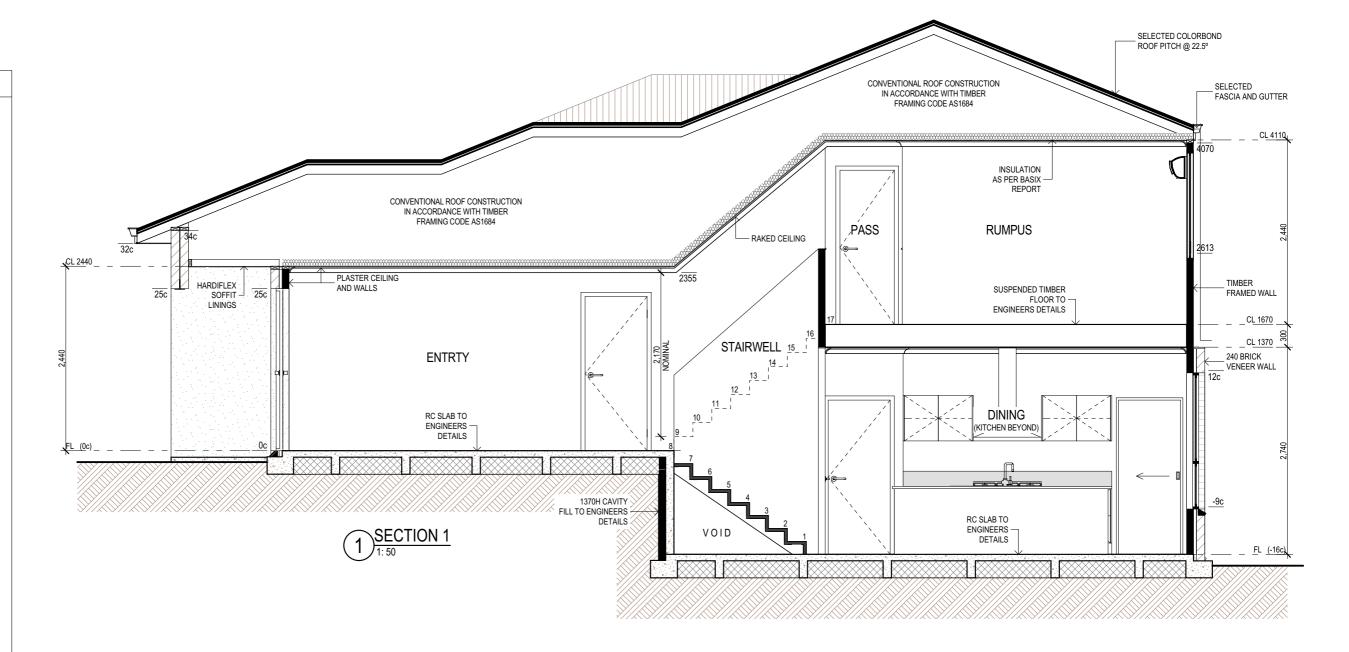

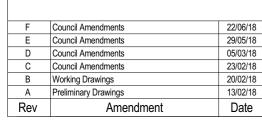





	PROPOSED NEW RE
CLIENT	FOR DANIEL & SA
DATE/	AT 7 ALLISON S
BUILDER	WEST HOBA
DATE/	

POSED NEW RESIDENCE	BASIX CERT. No.		SCALE	1:50
DANIEL & SARAH VAUTIN		PRELIM	DATE	22/06/18
7 ALLISON STREET,	PLAN		DRAWN	VN-HL
,	HIL	LGROVE 234	CHECKED	
WEST HOBART, TAS 7000	TITLE		JOB No.	DWG No.
	S	ECTION 1	T.B.A.	04-1

GENERAL NOTES

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TIMBER FRAMINGTO BE IN ACCORDANCE WITH AS1684. NATIONAL TIMBER FRAMING CODE

SUB-FLOOR VENTILATION TO COMPLY WITH PART 3.4.1 BCA VOL. TWO $\,$

WHERE ROOF TRUSSES ARE NOMINATED DESIGN & SPECIFICATION TO BE BY MANUFACTURER.

BALUSTRADES TO COMPLY WITH BCA PART 3.9.2 $\,$

POOL SAFETY FENCE TO COMPLY WIT AS1926.1 & SWIMMING POOLS ACT

INSTALLATION OF SMOKE DETECTORS TO COMPLY WITH AS3786.

PLUMBING & DRAINAGE SYSTEMS TO COMPLY

TERMITE MANAGEMENT SYSTEMS TO COMPLY WITH AS3660.

CONCRETE CONSTRUCTION TO BE IN ACCORDANCE WITH AS3600.

MASONRY CONSTRUCTION TO BE IN ACCORDANCE WITH AS3700.

DAMP-PROOF COURSE & FLASHINGS TO BE IN ACCORDANCE WITH AS/NZS 2904.

UNPLASTICISED PVC (UPVC) DOWNPIPE & FITTINGS FOR RAINWATER TO COMPLY WITH AS1273

INSTALLATION OF SHEET ROOF & WALL CLADDING TO COMPLY WITH AS1273


ALL PEDESTRIAN SURFACES TO COMPLY WITH AS/NZS3661 SLIP RESISTANCE


GLASS TO BE SELECTED & INSTALLED IN ACCORDANCE WITH AS1288 & AS 2047.

WATERPROOFING OF WET AREAS TO COMPLY WITH AS3740

ELECTRICAL INSTALLATIONS TO COMPLY WITH

PLEASE NOTE: THE STANDARDS REFERENCED IN THE TABLE ARE THE RELEVANT VERSION ADOPTED BY THE BCA AT THE TIME THE CONSTRUCTION CERTIFICATE OR COMPLYING DEVELOPEMNT CERTIFICATE APPLICATION WAS LODGED.

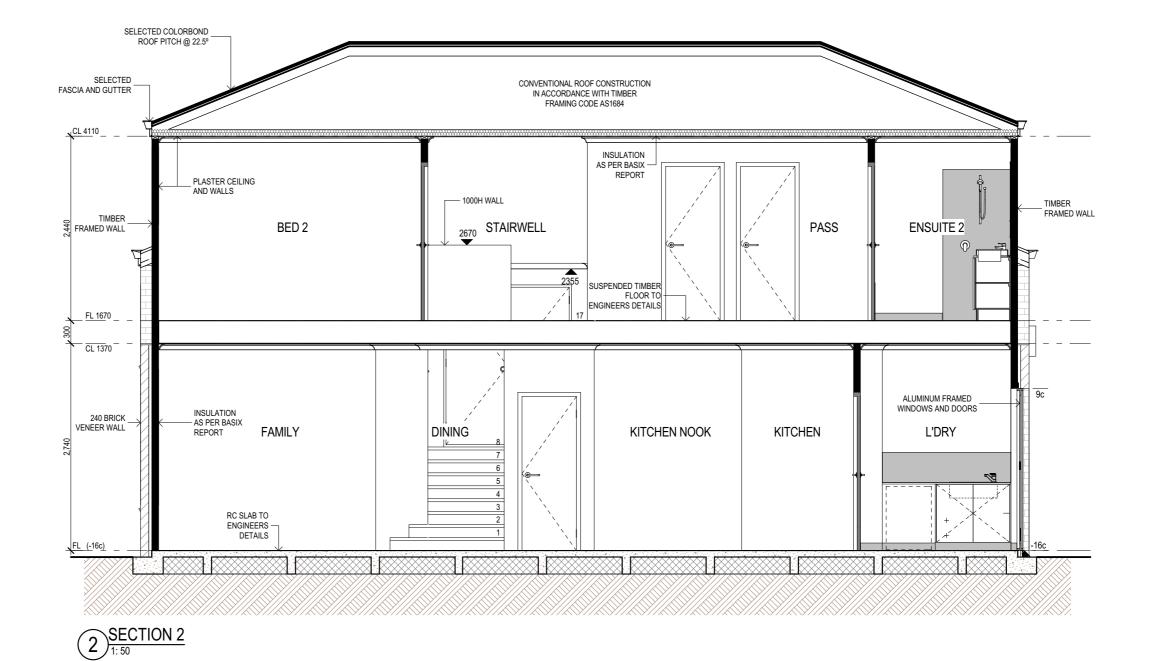

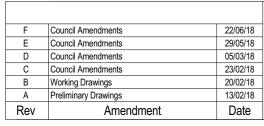






	PROPOSED NEW RESIDENCE
CLIENT	FOR DANIEL & SARAH VAUTIN
DATE/	AT 7 ALLISON STREET,
BUILDER	WEST HOBART, TAS 7000
DATE/	

BASIX CERT. No.	SCALE	1:50
PRELIM	DATE	22/06/18
PLAN	DRAWN	VN-HL
HILLGROVE 23	34 CHECKED	
TITLE	JOB No.	DWG No.
SECTION 2	2 T.B.A.	04-2

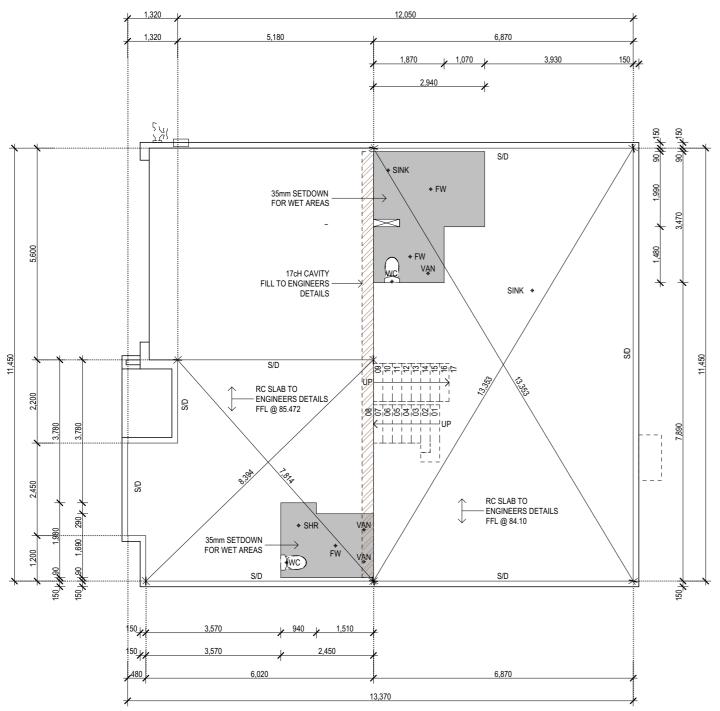

PLUMBER AND CONCRETER TO CONFIRM ALL PC ITEMS FOR SLAB PENETRATION

3. FOOTINGS AND SLAB CONSTRUCTION TO BE IN ACCORDANCE WITH ANY GEOTECHNICAL REPORT & ENGINEER'S DETAIL FOR THIS ALLOTMENT.

Ground Slab Layout

F	Council Amendments	22/06/18
Е	Council Amendments	29/05/18
D	Council Amendments	05/03/18
С	Council Amendments	23/02/18
В	Working Drawings	20/02/18
Α	Preliminary Drawings	13/02/18
Rev	Amendment	Date



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3660.1 1995 AND B.C.A. 3.1.3.

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	OLILIVI	
	DATE/	
D	BUILDER	
H	DATE/	

Suspended Timber Floor Layout Scale 1:100

1,820 1,110

+ FW

35mm SETDOWN

FOR WET AREAS

SUSPENDED TIMBER FLOOR -TO ENGINEERS DETAILS

FFL @ 87.14

+ SHR

*BATH

1,910

8688888

PROPOSED NEW RESIDENCE FOR DANIEL & SARAH VAUTIN AT 7 ALLISON STREET, WEST HOBART, TAS 7000


BASIX CERT. No.	SCALE	1:100
PRELIM	DATE	22/06/18
PLAN	DRAWN	VN-HL
HILLGROVE 234	CHECKED	
SLAB LAYOUT	JOB No. T.B.A.	DWG No. 05-1

OFFSETS AND DIMENSIONS

NOTES

1. VERIFY ALL DIMENSIONS PRIOR TO COMMENCEMENT. 2. ALL PLAN DIMENSIONS ARE TO OUTSIDE OF BRICK WORK UNLESS NOTED OTHERWISE.

4. TERMITE PROTECTION TO BE IN ACCORDANCE WITH AS

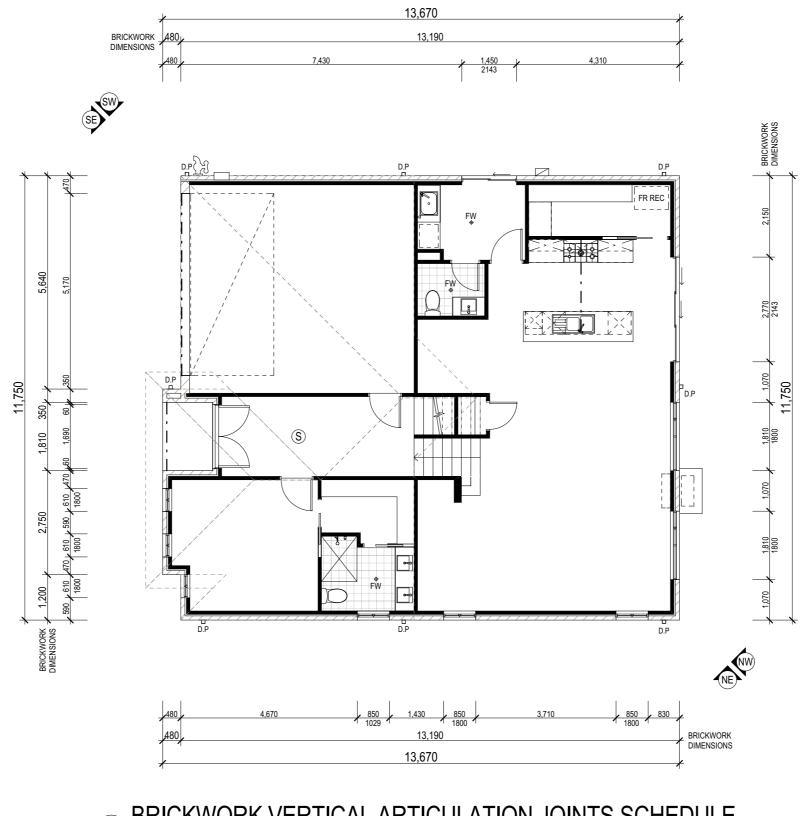

BRICKWORK VERTICAL ARTICULATION JOINTS SCHEDULE


BRICKWORK ARTICULATION JOINTS

LEGEND

In straight, continuous walls having no openings, at no more than 7.0m.

BRICKWORK ARTICULATION

- Where the height of the wall changes by more 20%, at the position of change in height; and Where openings more than 900x900mm occur, at not more than 5m centres and positioned in line with one edge of the opening; and
- Where walls change thickness; and
- At control or construction joints in footing slab; and
- At junctions of walls constructed of different masonry materials; and At a distance from all corners between 2m-4.5m.

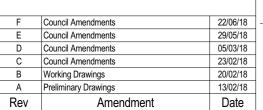





	CLIENT	
	DATE/	
	BUILDER	
Т	DATE / /	


PROPOSED NEW RESIDENCE FOR DANIEL & SARAH VAUTIN AT 7 ALLISON STREET, WEST HOBART, TAS 7000

/ERTICAL LEG IN CAVITY	
ARTICULATION JOINT	
MIN 110	•
WINDOW/DOOR FRAME ARTICULATION JOINT	
SLIP JOINT BELOW LINTEL 2 LAYERS OF DPC)	

STEEL LINTEL WITH

BRICKWORK ARTICULATION OVER WINDOW OR DOOR

BASIX CERT. No.	SCALE	1:100
PRELIM	DATE	22/06/18
PLAN	DRAWN	VN-HL
HILLGROVE 234	CHECKED	
BRICKWORK SETOUT	JOB No. T.B.A.	DWG No. 05-2

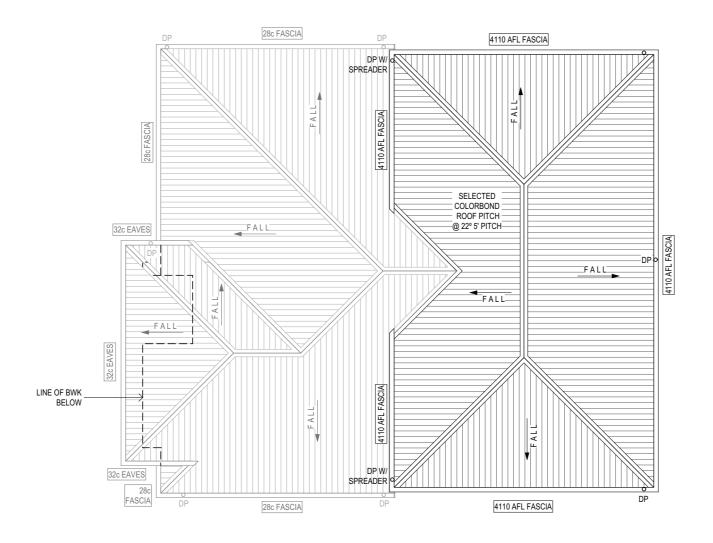



ROOF AREAS (COLOR	BOND)
AREA [m2 ON THE FLAT]	157.31
AREA [m2 ON THE RAKE]	169.77

F	Council Amendments	22/06/18
Е	Council Amendments	29/05/18
D	Council Amendments	05/03/18
С	Council Amendments	23/02/18
В	Working Drawings	20/02/18
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Rev	Amendment	Date




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	PRU	PUSED
CLIENT	FOR	DANI
DATE/	AT	7 ALL
BUILDER		WES
DATE / /		

PROPOSED NEW RESIDENCE
FOR DANIEL & SARAH VAUTIN
AT 7 ALLISON STREET,
WEST HOBART, TAS 7000

BASIX CERT. No.		SCALE	1:100
	PRELIM	DATE	22/06/18
PLAN		DRAWN	VN-HL
	HILLGROVE 234	CHECKED	
TITLE		JOB No.	DWG No.
	ROOF PLAN	T.B.A.	05-3



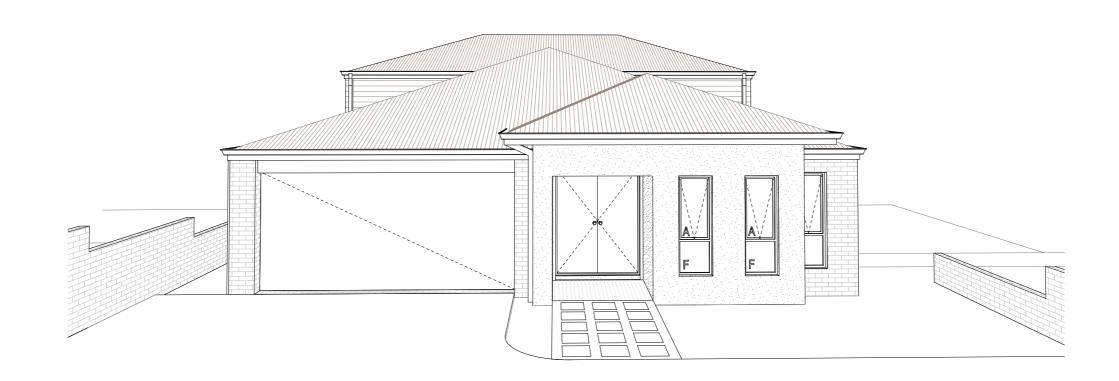

F	Council Amendments	22/06/18
Е	Council Amendments	29/05/18
D	Council Amendments	05/03/18
С	Council Amendments	23/02/18
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Rev	Amendment	Date







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	CLIENT	
	DATE/	
ID	BUILDER	
NT	DATE	

_			
	BASIX CERT. No.	SCALE	
	PRELIM	DATE	22/06/18
	PLAN	DRAWN	VN-HL
	HILLGROVE 234	CHECKED	
	PERSPECTIVES	JOB No. T.B.A.	DWG No.



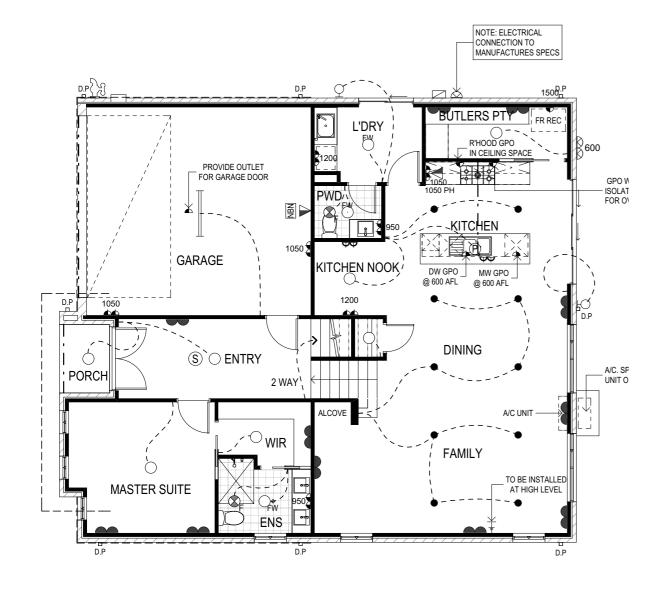

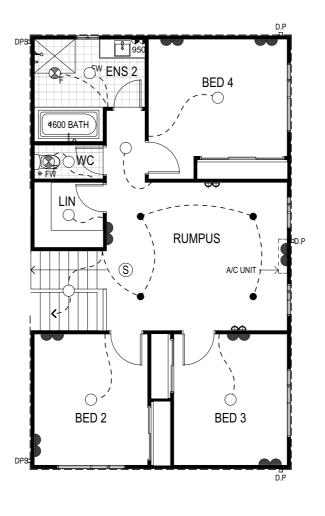ELECTRICAL LEGEND		
No.	SYMBOL	TYPE
1	——	1200L DOUBLE FLOURO WITH DIFFUSER
1	2 WAY	2-WAY SWITCH
18	0	CEILING LIGHT
8	A	DOUBLE GPO - NOTED HT AFL
19		DOUBLE GPO @ 300 AFL
4	ΔΔ.	DOUBLE USB PORT @ NOTED HT AFL
1	<i>∞</i> ∞	DOUBLE WATER PROOF GPO
14	•	DOWNLIGHT
4	8	FLUMED EXHAUST FAN
1	V	NBN POINT
1	P	PENDANT LIGHT
1	V	PHONE POINT
6	4	SINGLE GPO @ NOTED HT AFL
1	\triangle	SINGLE WATER PROOF GPO
1	±	TV POINT
2	Ю	WALL LIGHT @ 1800 AFL
S SMOKE DETECTORS TO BE CONNECTED TO MAINS POWER AND HAVING A STANDBY POWER SUPPLY IN ACCORDANCE WITH AS3786-1993		
APPROVED DOWNLIGHT NON-VENTILATED COVER OR SHIELD		

TO ALL CEILING PENETRATIONS FOR LIGHTING

Ground Floor Electrical Plan Scale 1: 100

2 Upper Floor Electrical Plan Scale 1:100


F	Council Amendments	22/06/18
E	Council Amendments	29/05/18
D	Council Amendments	05/03/18
С	Council Amendments	23/02/18
В	Working Drawings	20/02/18
Α	Preliminary Drawings	13/02/18
Rev	Amendment	Date




Hotondo
Homes
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	CLIENT
	DATE/
D	BUILDER
ΙT	DATE / /

BASIX CERT. No.	SCALE	1:100
PRELIM	DATE	22/06/18
PLAN	DRAWN	VN-HL
HILLGROVE 234	CHECKED	
TITLE	JOB No.	DWG No.
ELECTRICAL	T.B.A.	07



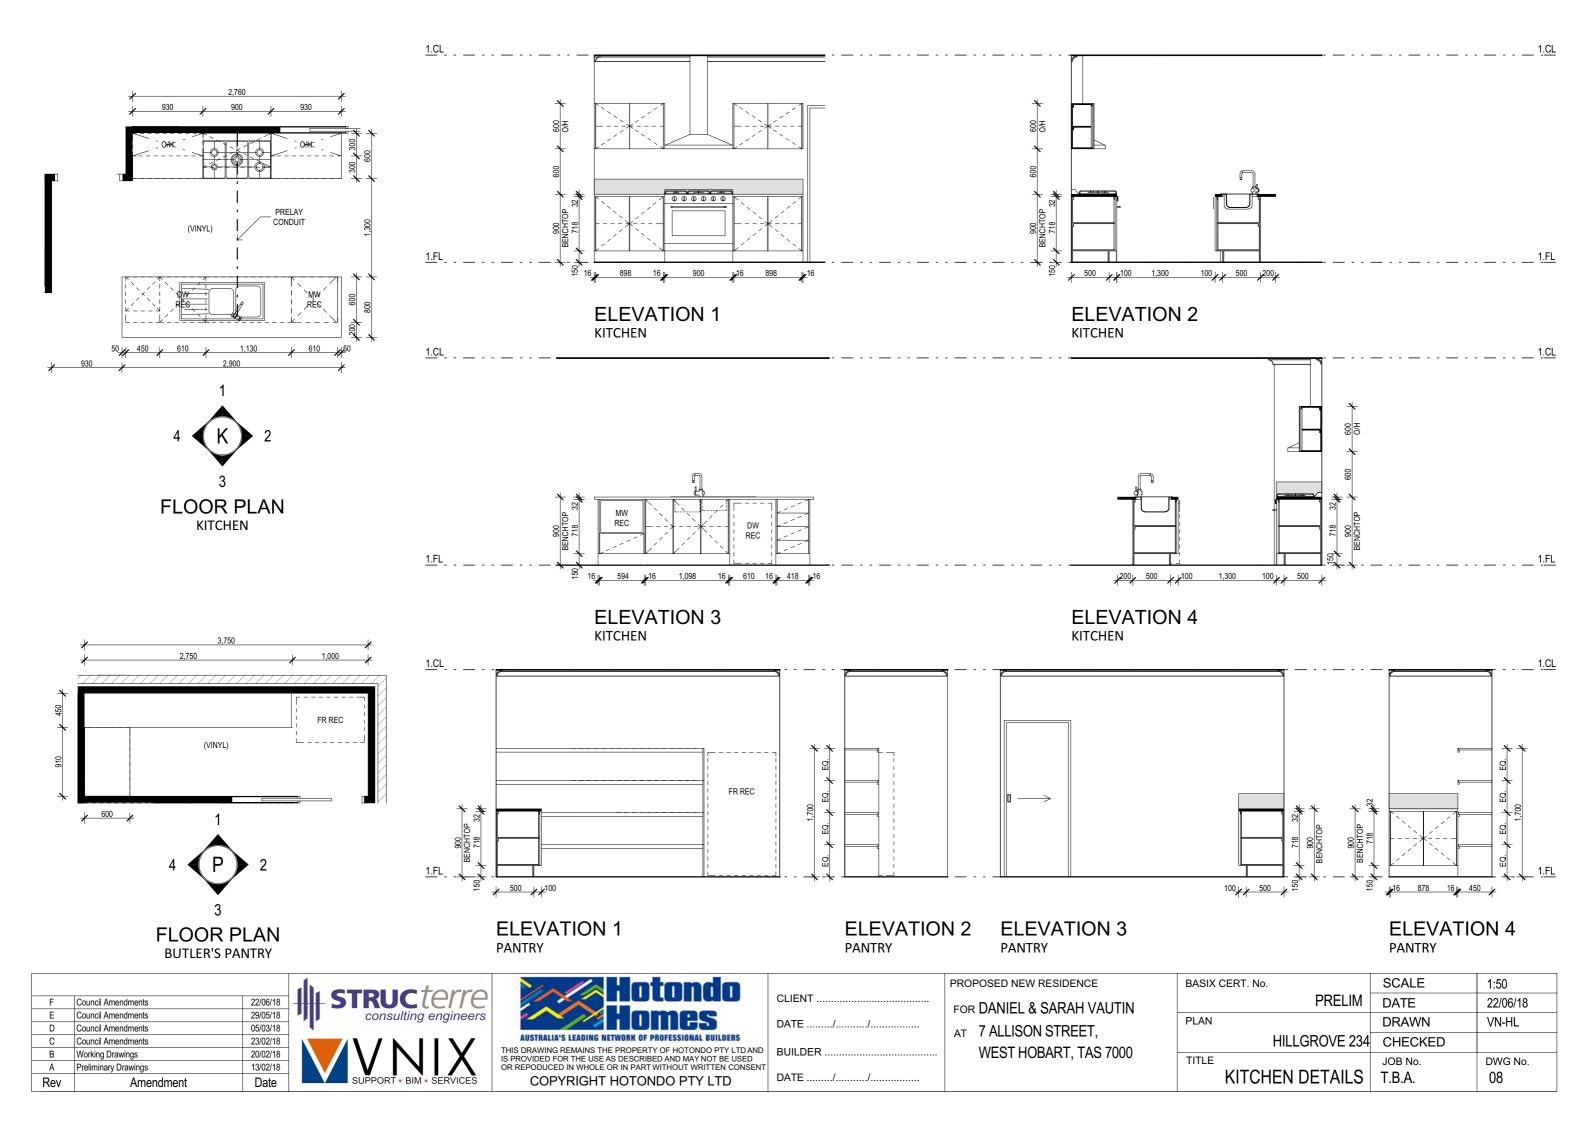

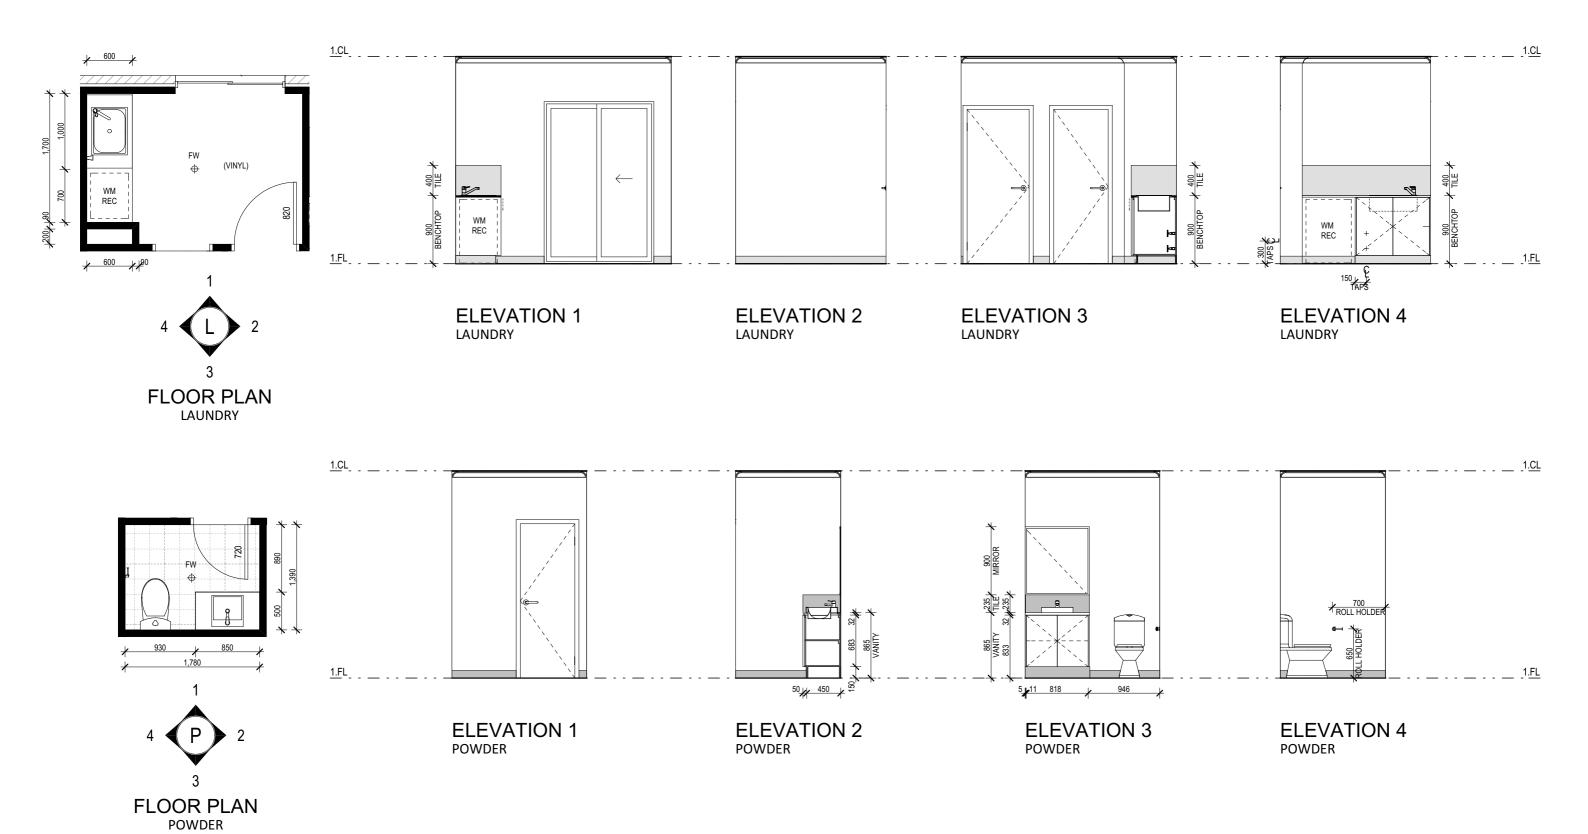F	Council Amendments	22/06/18
E	Council Amendments	29/05/18
D	Council Amendments	05/03/18
С	Council Amendments	23/02/18
В	Working Drawings	20/02/18
Α	Preliminary Drawings	13/02/18
Rev	Amendment	Date






		PR
	CLIENT	FC
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Т	DATE/	

PROPOSED NEW RESIDENCE	
FOR DANIEL & SARAH VAUTIN	
AT 7 ALLISON STREET,	
WEST HOBART, TAS 7000	

BASIX CERT. No.	SCALE	1:50
PRELIM	DATE	22/06/18
PLAN	DRAWN	VN-HL
HILLGROVE 234	CHECKED	
TITLE	JOB No.	DWG No.
WET AREA DETAILS	T.B.A.	09-1

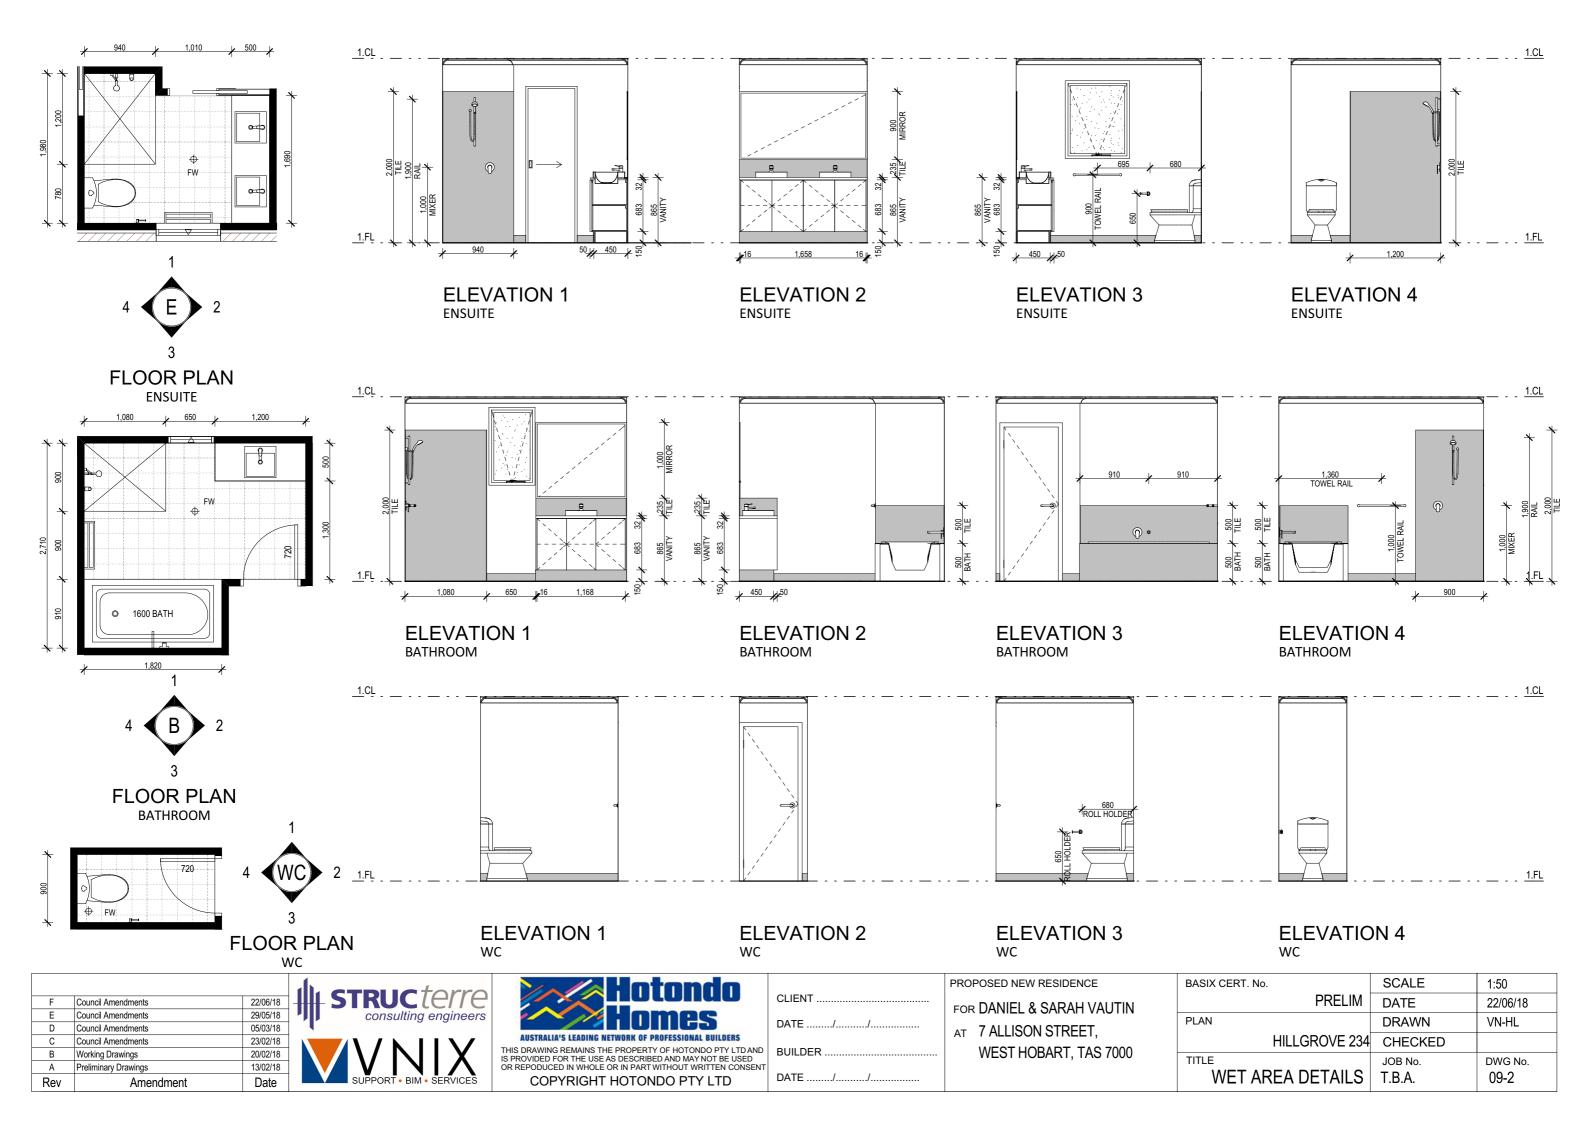



Attention: Jill Hickie - Senior Park's Planner

RE: 7 Allison Street & 40 Hill Street, West Hobart TAS 7000

Partial Demolition, Alterations and Multiple Dwelling

Application No. PLN-18-88

I am writing in regards to the New Proposed Sewer Connection that needs to Run from the New Proposed Dwelling and the Existing Dwelling at 7 Allison Street, West Hobart into and through the Park at 40 Hill Street, West Hobart.

Proposal:

- New Dwelling: New Double Storey Dwelling to be Built at the Rear of Existing Dwelling. New DN150mm Sewer Lines attached and Leaving the Dwelling as required.
- 2) Existing Dwelling: Sewer Line connected to current Dwelling at 7 Allison Street, West Hobart runs out of this Dwelling and across into the Neighbouring Property at 5 Allison Street, West Hobart and down into the Mains Connection Line at 40 Hill Street, West Hobart. We propose that we cut and Cap this line off at the Fence line to the Neighbouring Property at 5 Allison Street, West Hobart and re-direct into the New DN1050 Sewer Manhole and New DN1050 Sewer Line as shown on DWG No. 01-7 of Working Drawings provided.
- 3) New & Existing Dwelling: We Propose that we run a New DN150mm Sewer Line from the Existing Dwelling Connection Point, Down the Right Hand Side of the Boundary at Approximately 900mm Deep or minimum of 1.65% Gradient. This will Join up into the Proposed New Dwelling's Sewer Line and Run Down to the Bottom Right Hand Side of the Lot where there will be a New DN1050 Sewer Manhole installed as Shown on DWG No. 01-7.




- 4) New Sewer Line: We Propose to run the New DN150mm Sewer Line from the New DN1050 Sewer Manhole inside the Property at 7 Allison Street, West Hobart. We will then run it into and through the middle of the New Pipeline and Sewer Services Easement located within the Park at 40 Hill Street, West Hobart. This line will be out at approximately 1250mm from the Boundary Lines of the Existing Dwellings and into the second New DN1050 Sewer Manhole at the Junction of the Existing Sewer Line for 5 Allison Street, West Hobart which will be located approximately 15.5 Meters from 7 Allison Street Boundary and 500mm out from 5 Allison Street Boundary. The Existing 150 VC Line running through 40 Hill Street, West Hobart as shown on DWG No. 01-7 will also connect into this manhole. This Easement will be approximately 16.0 Meters Long x 2.5 Meters Wide x 900mm Deep, Minimum 1.65% Gradient or required connection Depth. There is a Tree at 15.0 Meters from 7 Allison Street Boundary Line and 2.4 Meters out from 5 Allison Street Boundary Line. Apart from that, No other restrictions. All live Connections by Taswater at Developers Cost.
- 5) Flora and Fauna: No existing Flora/Fauna or Trees will be affected, Damaged or removed in any way within the Boundaries of 7 Allison Street, 5 Allison Street and 40 Hill Street, West Hobart during the proposed works.
- 6) Construction Works: Mechanical Excavations and Manual Excavations. Trench Works for New Pipeline and Sewer Services Easement located within the Park at 40 Hill Street, West Hobart, will have Site Security Fencing surrounding entire excavation site and will be sign posted as required. Excavations Trench will be approximately 450mm Wide. Wider at DN1050 Sewer Manhole locations as shown on DWG No. 01-7. All Excavations will be battered / benched as required, if required. ONLY Qualified Person's with appropriate Qualifications, Confined Space Accreditation and Appropriate Insurances will undertake any works inside Trenches.
- 7) Operating Hours: Proposed Works to take place between the hours of 7:30am and 4:00pm Monday to Friday.
- 8) Site Meeting: We are more than happy to meet on Both Sites to Walkthrough the proposed works with the relevant Council Members to help get things through.
- 9) Proposal has been reviewed and approved by: Nathan Board Builder # CC7215

Michael Coates - Plumber # 1461276

Yours Sincerely,

Nathan Board

Hotondo Homes Sorell

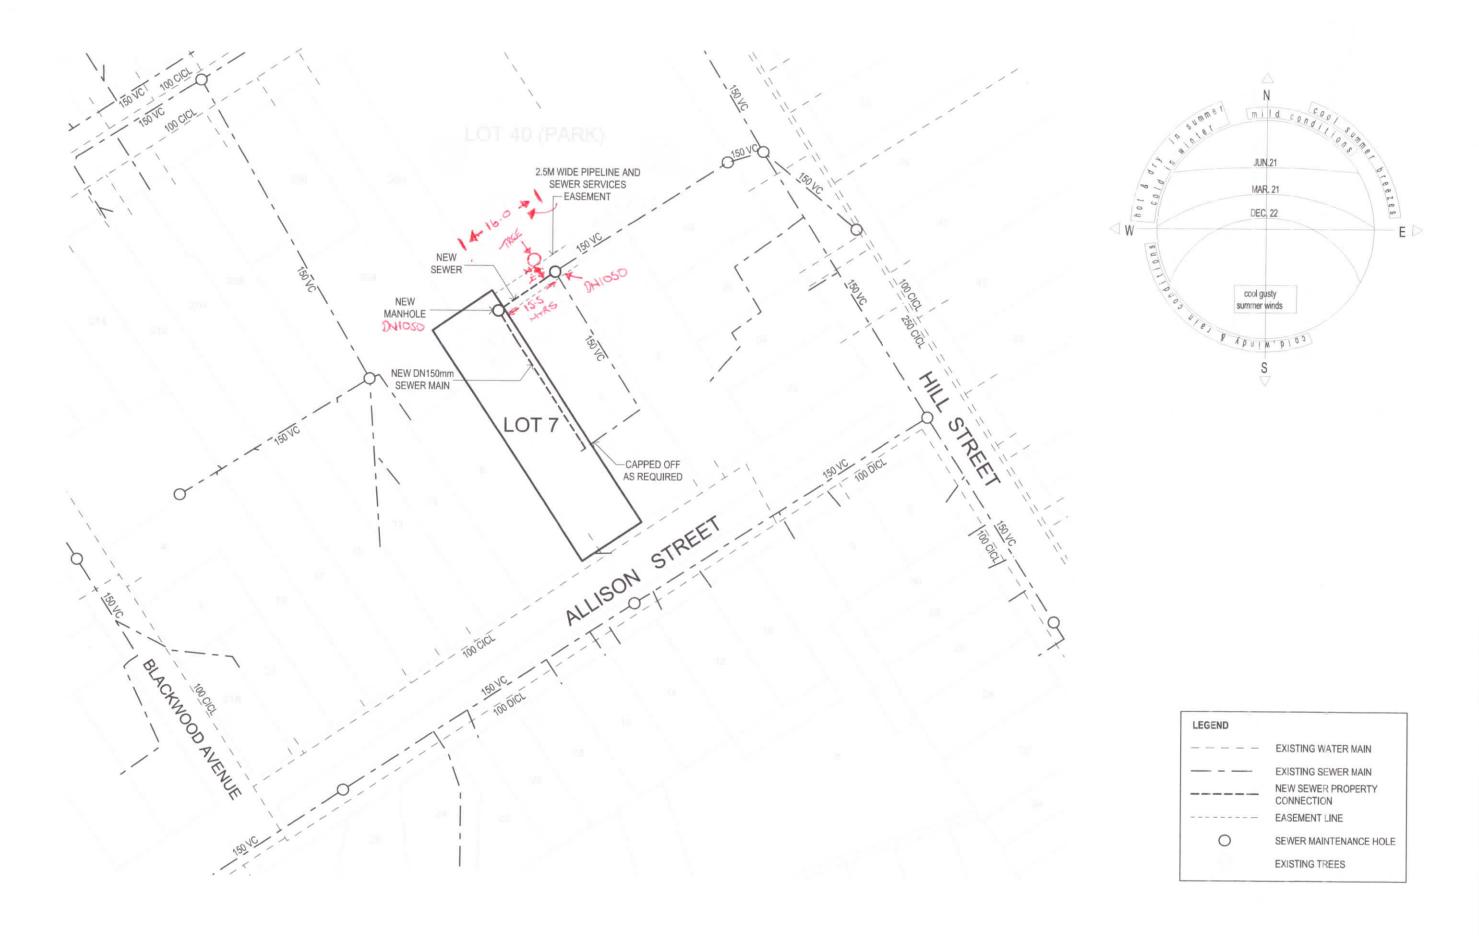

Rev	Amendment	Date
Α	Preliminary Drawings	13/02/18
В	Working Drawings	20/02/18
C	Council Amendments	23/02/18
D	Council Amendments	05/03/18
E	Council Amendments	29/05/18
F	Council Amendments	22/06/18





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BASIX CERT. No.		SCALE	1:800, 1:200
	PRELIM	DATE	22/06/18
PLAN	LAN	DRAWN	VN-HL
	HILLGROVE 234	CHECKED	
TITLE	SITE UTILITIES	JOB No. T.B.A.	DWG No.



Submission to Planning Authority Notice

Council Planning Permit No.	PLN-18-88		Council notice date	21/02/2018	
TasWater details	TasWater details				
TasWater Reference No.	TWDA 2018/00247-HCC		Date of response	15/08/2018	
TasWater Contact	Anthony Cengia	Phone No.		(03) 6237 8243	
Response issued to					
Council name	HOBART CITY COUNCIL				
Contact details	coh@hobartcity.com.au				
Development details					
Address	7 ALLISON ST, WEST HOBART			Property ID (PID)	5537341
Description of development	Partial demolition, alterations and multiple dwelling				
Schedule of drawings/documents					
Prepared by		Drawing/doo	cument No.	Revision No.	Date of Issue
Structerre		01-7(1)			22/06/2018
Structerre		00 to 09-2			22/06/2018
Conditions					

SUBMISSION TO PLANNING AUTHORITY NOTICE OF PLANNING APPLICATION REFERRAL

Pursuant to the *Water and Sewerage Industry Act* 2008 (TAS) Section 56P(1) TasWater imposes the following conditions on the permit for this application:

CONNECTIONS, METERING & BACKFLOW

- A suitably sized water supply with metered connections / sewerage system and connections to each dwelling unit must be designed and constructed to TasWater's satisfaction and be in accordance with any other conditions in this permit.
- 2. Any removal/supply and installation of water meters and/or the removal of redundant and/or installation of new and modified property service connections must be carried out by TasWater at the developer's cost.

ASSET CREATION & INFRASTRUCTURE WORKS

- 3. Plans submitted with the application for Certificate(s) for Certifiable Work (Building and/or Plumbing) / Engineering Design Approval must, to the satisfaction of TasWater show, all existing, redundant and/or proposed property services and mains.
- 4. Prior to applying for a Permit to Construct new infrastructure the developer must obtain from TasWater Engineering Design Approval for new TasWater infrastructure. The application for Engineering Design Approval must include engineering design plans prepared by a suitably qualified person showing the hydraulic servicing requirements for water and sewerage to TasWater's satisfaction.
- 5. Prior to works commencing, a Permit to Construct must be applied for and issued by TasWater. All infrastructure works must be inspected by TasWater and be to TasWater's satisfaction.
- 6. In addition to any other conditions in this permit, all works must be constructed under the supervision of a suitably qualified person in accordance with TasWater's requirements.
- 7. Prior to the issue of a Certificate of Water and sewerage Compliance (Building and/or Plumbing) all



- additions, extensions, alterations or upgrades to TasWater's water and sewerage infrastructure required to service the development are to be constructed at the expense of the developer to the satisfaction of TasWater, with live connections performed by TasWater.
- 8. After testing to TasWater's requirements, of newly created works, the developer must apply to TasWater for connection of these works to existing TasWater infrastructure, at the developer's cost.
- 9. At practical completion of the water and sewerage works and prior to TasWater issuing a Consent to a Register Legal Document / applying to TasWater for a Certificate of Water and Sewerage Compliance (Building and/or Plumbing), the developer must obtain a Certificate of Practical Completion from TasWater for the works that will be transferred to TasWater. To obtain a Certificate of Practical Completion:
 - a. Written confirmation from the supervising suitably qualified person certifying that the works have been constructed in accordance with the TasWater approved plans and specifications and that the appropriate level of workmanship has been achieved;
 - b. A request for a joint on-site inspection with TasWater's authorised representative must be made;
 - c. Security for the twelve (12) month defects liability period to the value of 10% of the works must be lodged with TasWater. This security must be in the form of a bank guarantee;
 - d. As constructed drawings must be prepared by a suitably qualified person to TasWater's satisfaction and forwarded to TasWater.
- 10. After the Certificate of Practical Completion has been issued, a 12 month defects liability period applies to this infrastructure. During this period all defects must be rectified at the developer's cost and to the satisfaction of TasWater. A further 12 month defects liability period may be applied to defects after rectification. TasWater may, at its discretion, undertake rectification of any defects at the developer's cost. Upon completion, of the defects liability period the developer must request TasWater to issue a "Certificate of Final Acceptance". The newly constructed infrastructure will be transferred to TasWater upon issue of this certificate and TasWater will release any security held for the defects liability period.
- 11. The developer must take all precautions to protect existing TasWater infrastructure. Any damage caused to existing TasWater infrastructure during the construction period must be promptly reported to TasWater and repaired by TasWater at the developer's cost.
- 12. Ground levels over the TasWater assets and/or easements must not be altered without the written approval of TasWater.

56W CONSENT

13. Prior to the issue of the Certificate for Certifiable Work (Building) and/or (Plumbing) by TasWater the applicant or landowner as the case may be must make application to TasWater pursuant to section 56W of the Water and Sewerage Industry Act 2008 for its consent in respect of that part of the development which is built within a TasWater easement or over or within two metres of TasWater infrastructure.

The plans submitted with the application for the Certificate for Certifiable Work (Building) and/or (Plumbing) must show footings of proposed buildings located over or within 2.0m from TasWater pipes and must be designed by a suitably qualified person to adequately protect the integrity of TasWater's infrastructure, and to TasWater's satisfaction, be in accordance with AS3500 Part 2.2 Section 3.8 to ensure that no loads are transferred to TasWater's pipes. These plans must also include a cross sectional view through the footings which clearly shows;

a. Existing pipe depth and proposed finished surface levels over the pipe;



- b. The line of influence from the base of the footing must pass below the invert of the pipe and be clear of the pipe trench and;
- c. A note on the plan indicating how the pipe location and depth were ascertained.

BOUNDARY TRAP AREA

14. The proposed development is within a boundary trap area and the developer must provide a boundary trap that prevents noxious gases or persistent odours back venting into the property's sanitary drain. The boundary trap must be contained within the property boundaries and the property owner remains responsible for the ownership, operation and maintenance of the boundary trap.

DEVELOPMENT ASSESSMENT FEES

15. The applicant or landowner as the case may be, must pay a development assessment fee of \$211.63 to TasWater, as approved by the Economic Regulator and the fees will be indexed, until the date paid to TasWater.

The payment is required within 30 days of the issue of an invoice by TasWater.

Advice

General

For information on TasWater development standards, please visit http://www.taswater.com.au/Development/Development-Standards

For application forms please visit http://www.taswater.com.au/Development/Forms

Declaration

The drawings/documents and conditions stated above constitute TasWater's Submission to Planning Authority Notice.

Authorised by

Jason Taylor

Development Assessment Manager

TasWater Contact Details				
Phone	13 6992	Email	development@taswater.com.au	
Mail	GPO Box 1393 Hobart TAS 7001	Web	www.taswater.com.au	

Issue Date: August 2015
Page 3 of 3
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Version No: 0.1